

87-89 Guthrie Street, Osborne Park, Western Australia Telephone: (08) 9446 7361 Facsimile: (08) 9445 2998 Email: perth@cottage.com.au Website: www.cottage.com.au J/N: SCALE: DRAWN: DATE: 454362 *0*5 Jun 19 1:200 F.Croasdale

BUILDER: CLIENT: Carter LOT 65 #178 Little Marine Parade, Cottesloe Plan2689

SEC Dome Power Pole 9 Phone Pits W Water Conn.

[TP10.00] Top Pillar/Post [TW10.00] Top Wall [TR10.00] Top Retaining [TF10.00] Top Fence

OLD

AREA

TOWN OF COTTESLOE DATE RECEIVED

14/1/2021

▲ DISCLAIMER:

Lot boundaries drawn on survey are based on landgate plan only. Survey does not include title search and as such may not show easements or other interests not shown on plan. Title should be checked to verify all lot details and for any easements or other interests which may affect building on the property.

A DISCLAIMER: Survey does not include verification of cadastral boundaries. All features and levels shown are based on orientation to existing pegs and fences only which may not be on correct cadastral alignment. Any designs based or dependent on the location of existing features should have those features' location verified in relation to the true boundary.

DISCLAIMER:
Survey shows visible features only and will not show locations of underground pipes or conduits for internal or mains services. Verification of the location of all internal and mains services should be confirmed prior to finalisation of any design work.

DISCLAIMER:
Cottage & Engineering surveys accept no responsibility for any physical on site changes to the parcel or portion of the parcel of land shown on this survey including any adjoining neighbours levels and features that have occurred after the date on this survey. All Sewer details plotted from information supplied by Water Corporation.


DI SCLAI MER:


Due to lack of survey marks/pegs, all building offset dimensions & features are approximate only and positioned from existing pegs/fences and walls which may not be on the correct alignment and are to be verified when repegged. Any design that involves additions to any structures shown or portion of structures remaining after any demolition has taken place requires boundaries to be repegged and exact offsets provided to your designer/architect before any plans are produced and before any work is started on site.


LOT MISCLOSE 0.011 m

Refer to Survey

SOIL DESCRIPTION Sand

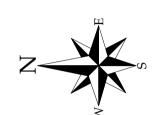

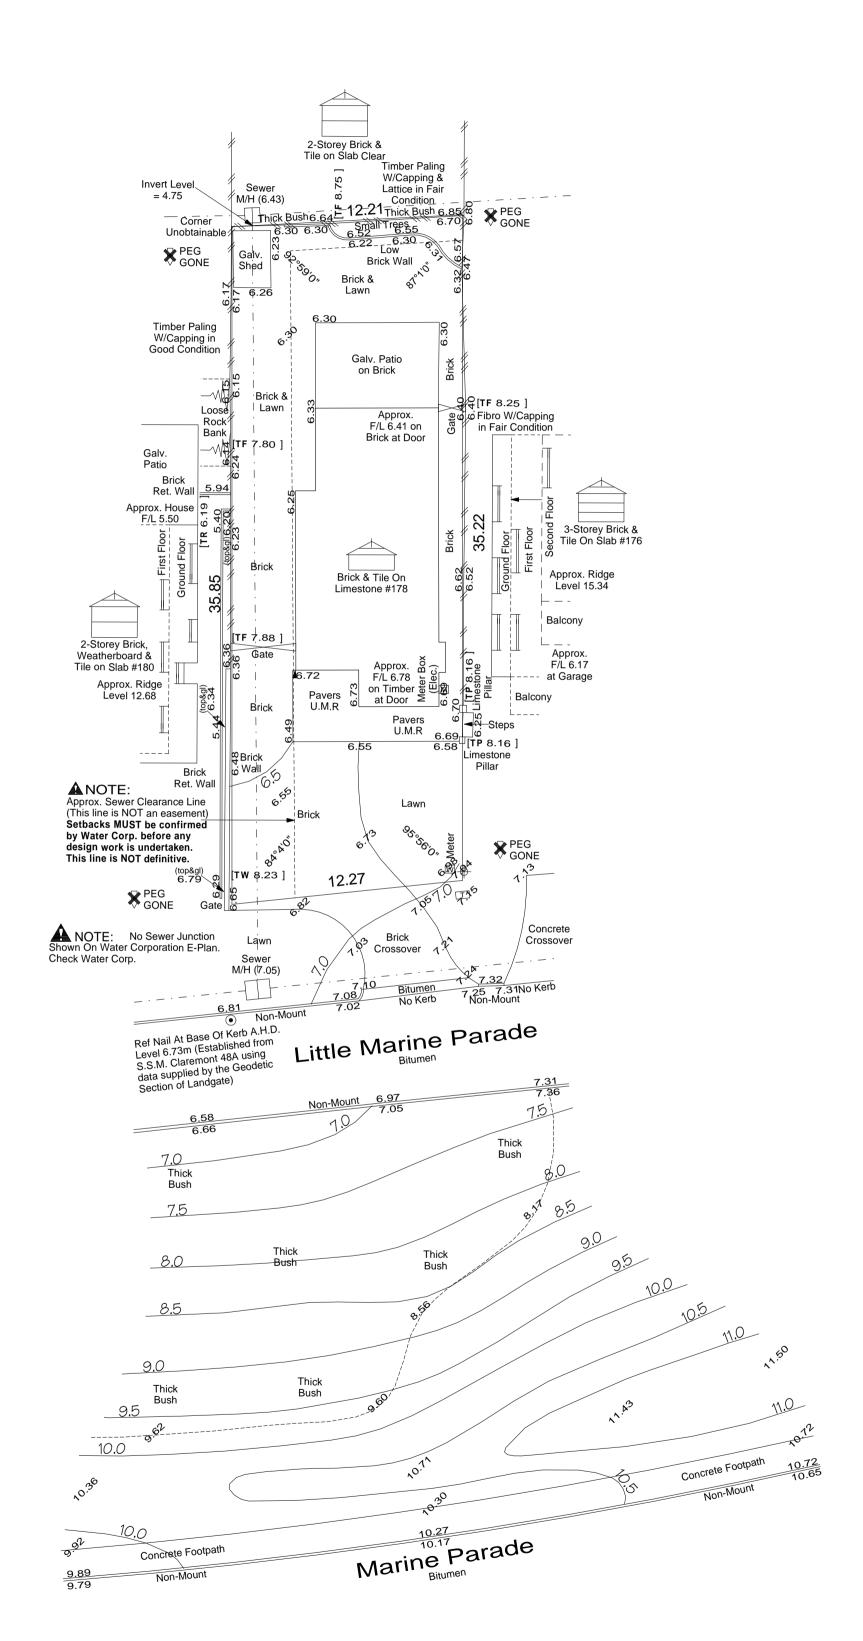

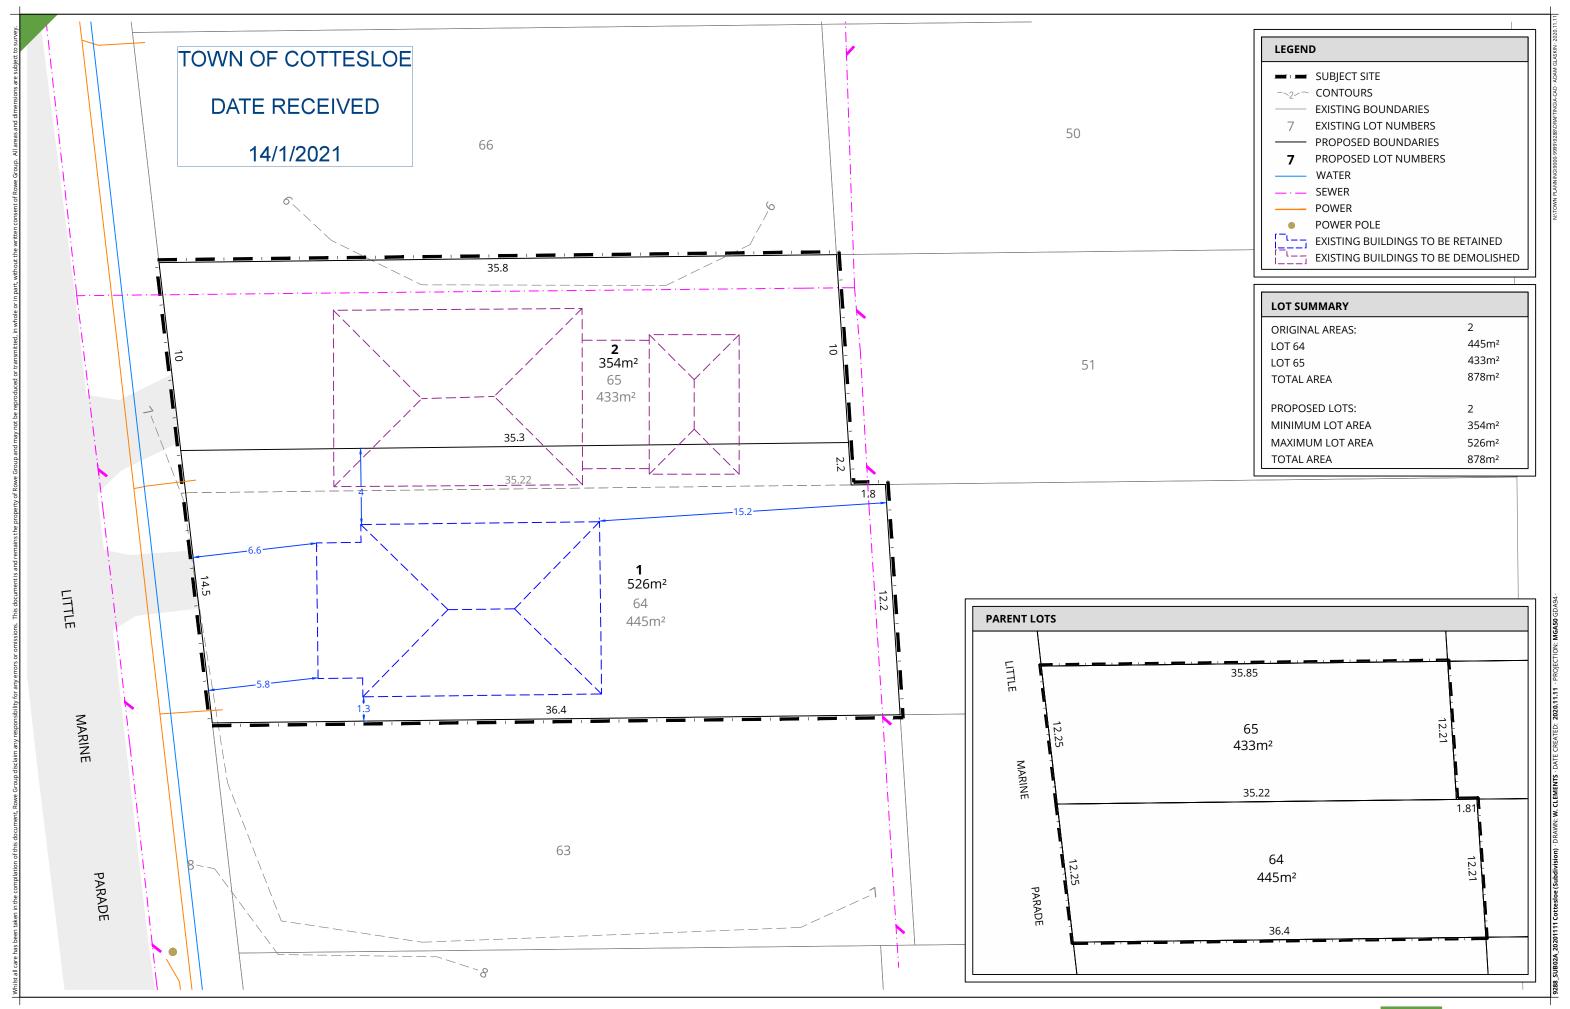





LOT 64 (No. 176) & LOT 65 (No. 178) LITTLE MARINE PARADE COTTESLOE








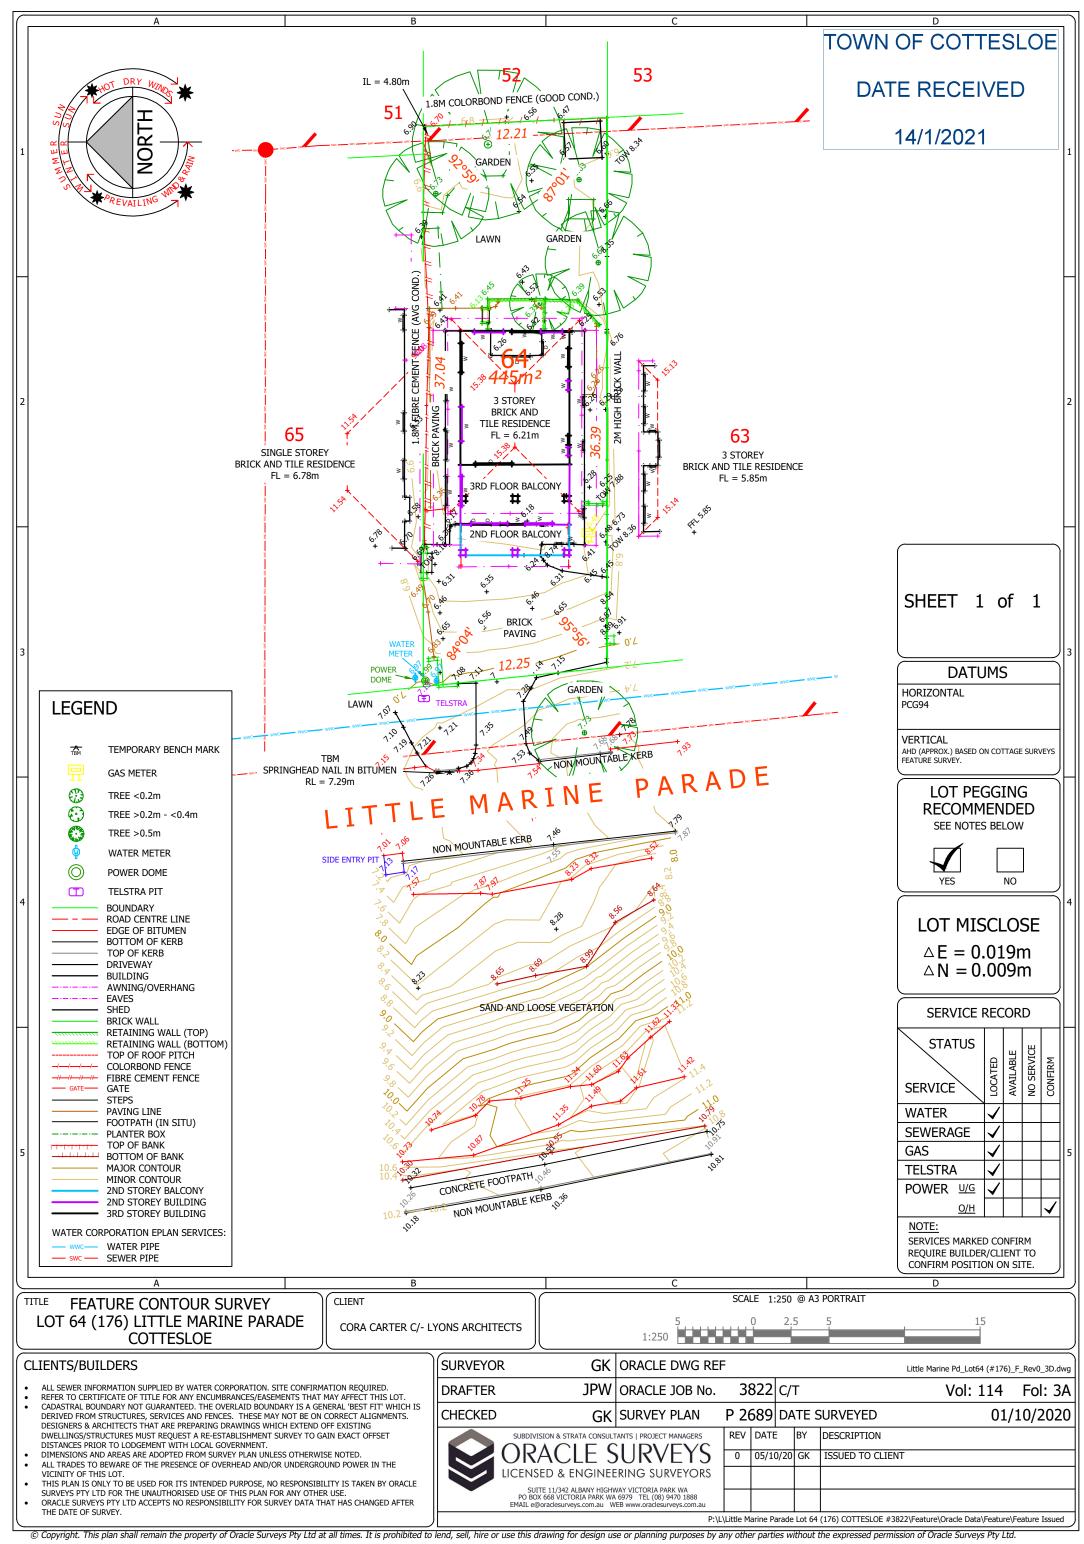


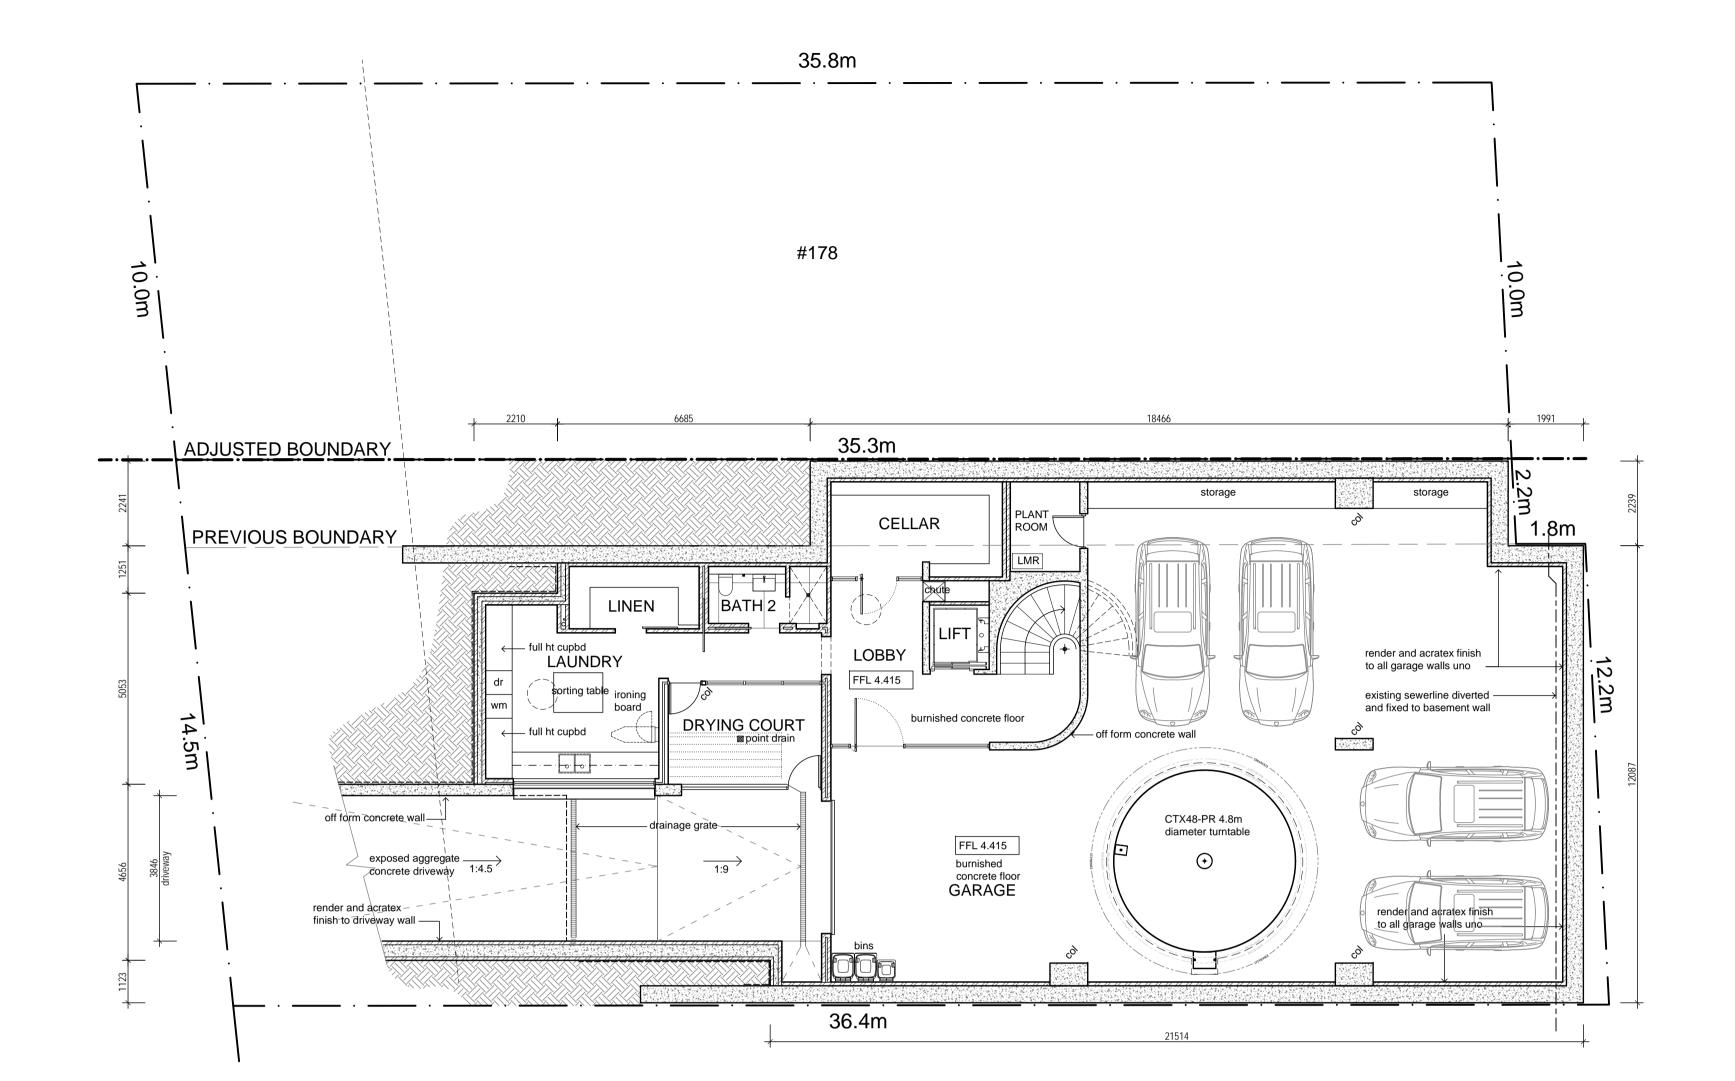

▼ Service Terrace 13963 ■ Upper Floor - Front 11113 residence beyond ▼ Ground Floor - Front 7760 Ground Floor - Rear 1200mm high board formed concrete front boundary wall 50% open aspect breezeblock above 1200mm

WEST ELEVATION - at Boundary

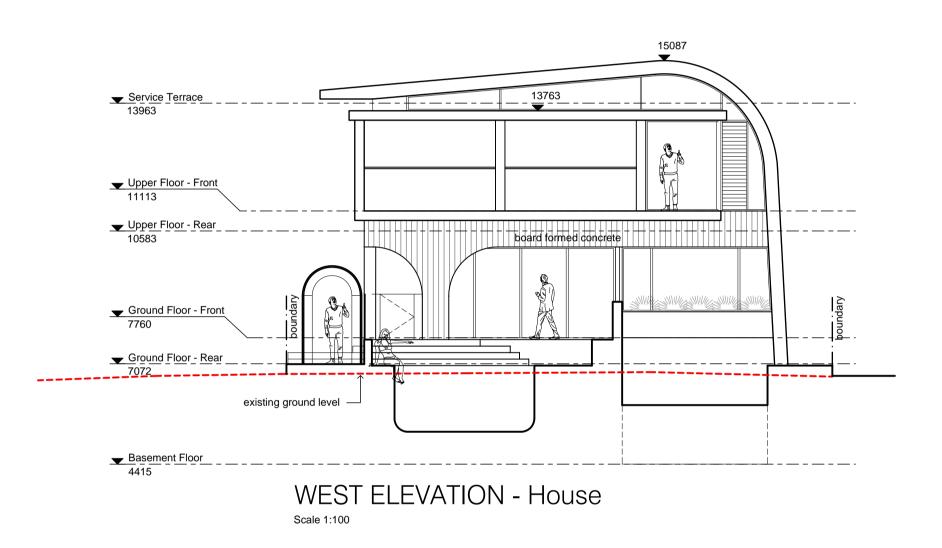


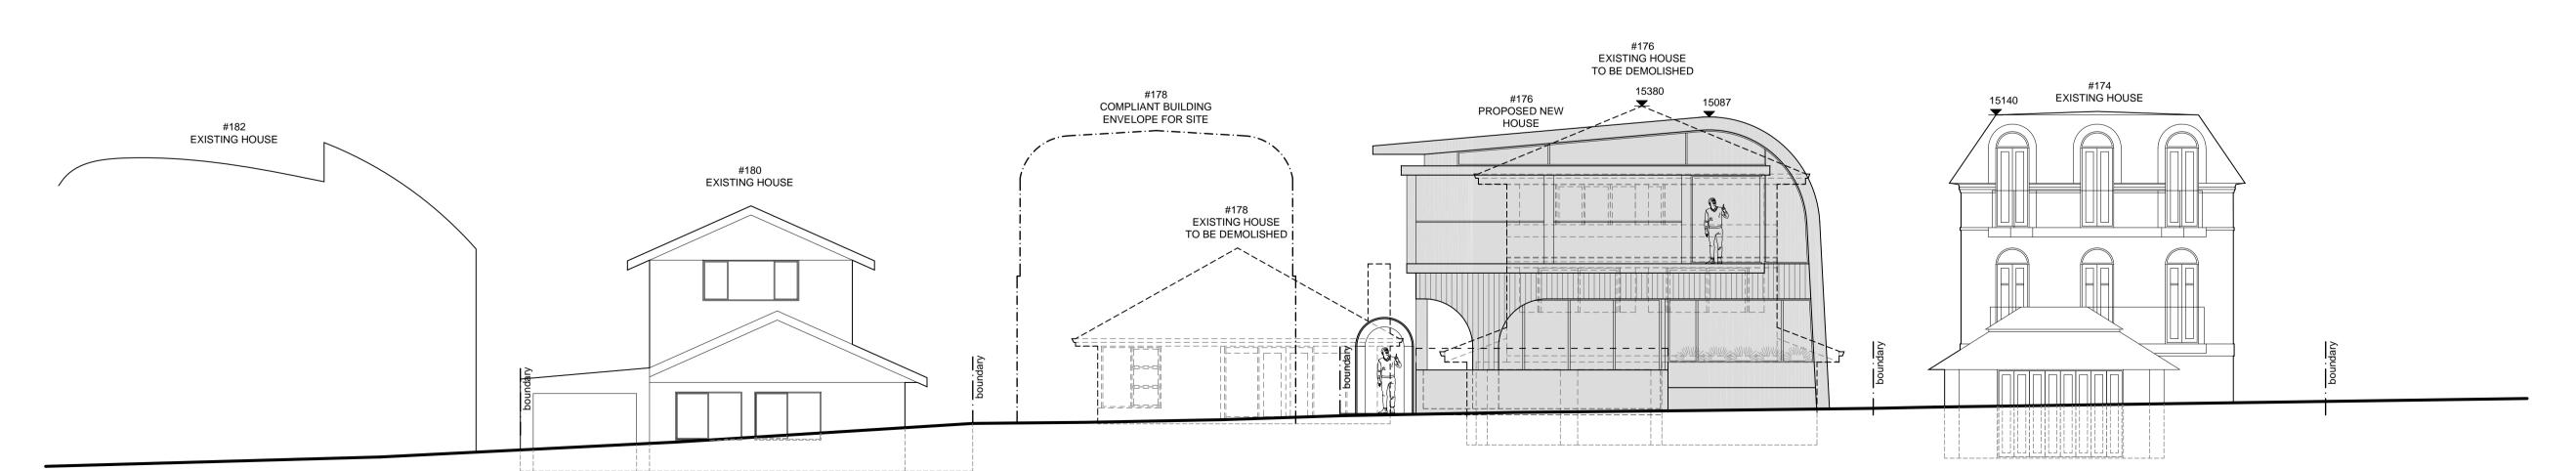

STREETSCAPE COMPOSITE


BASEMENT FLOOR PLAN

Scale 1:100

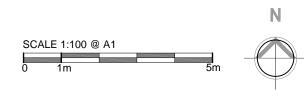






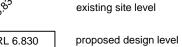




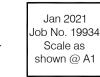





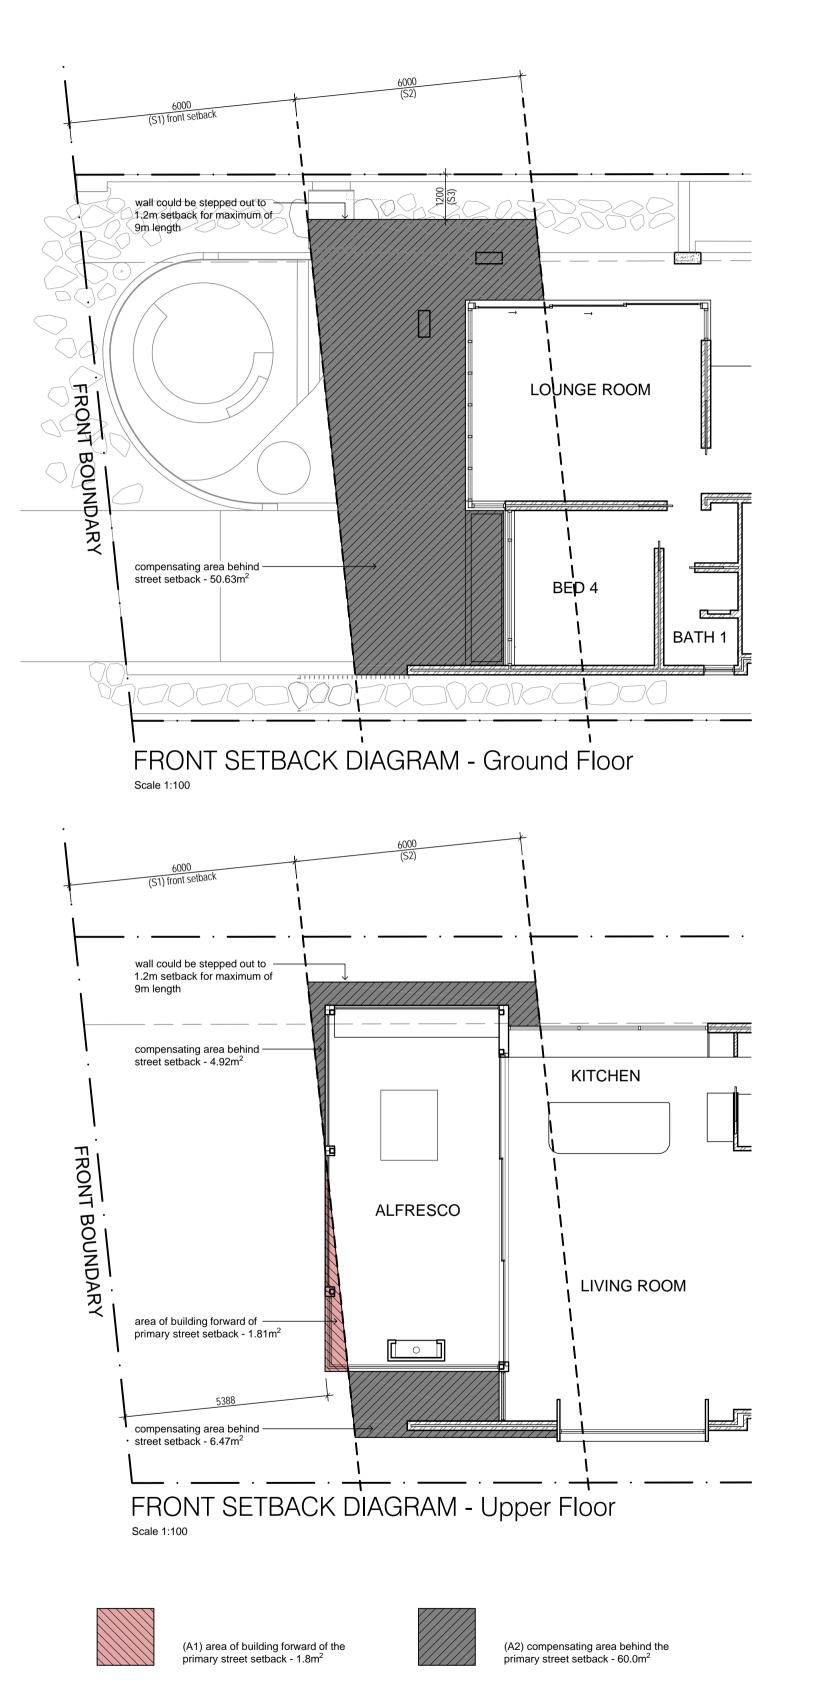











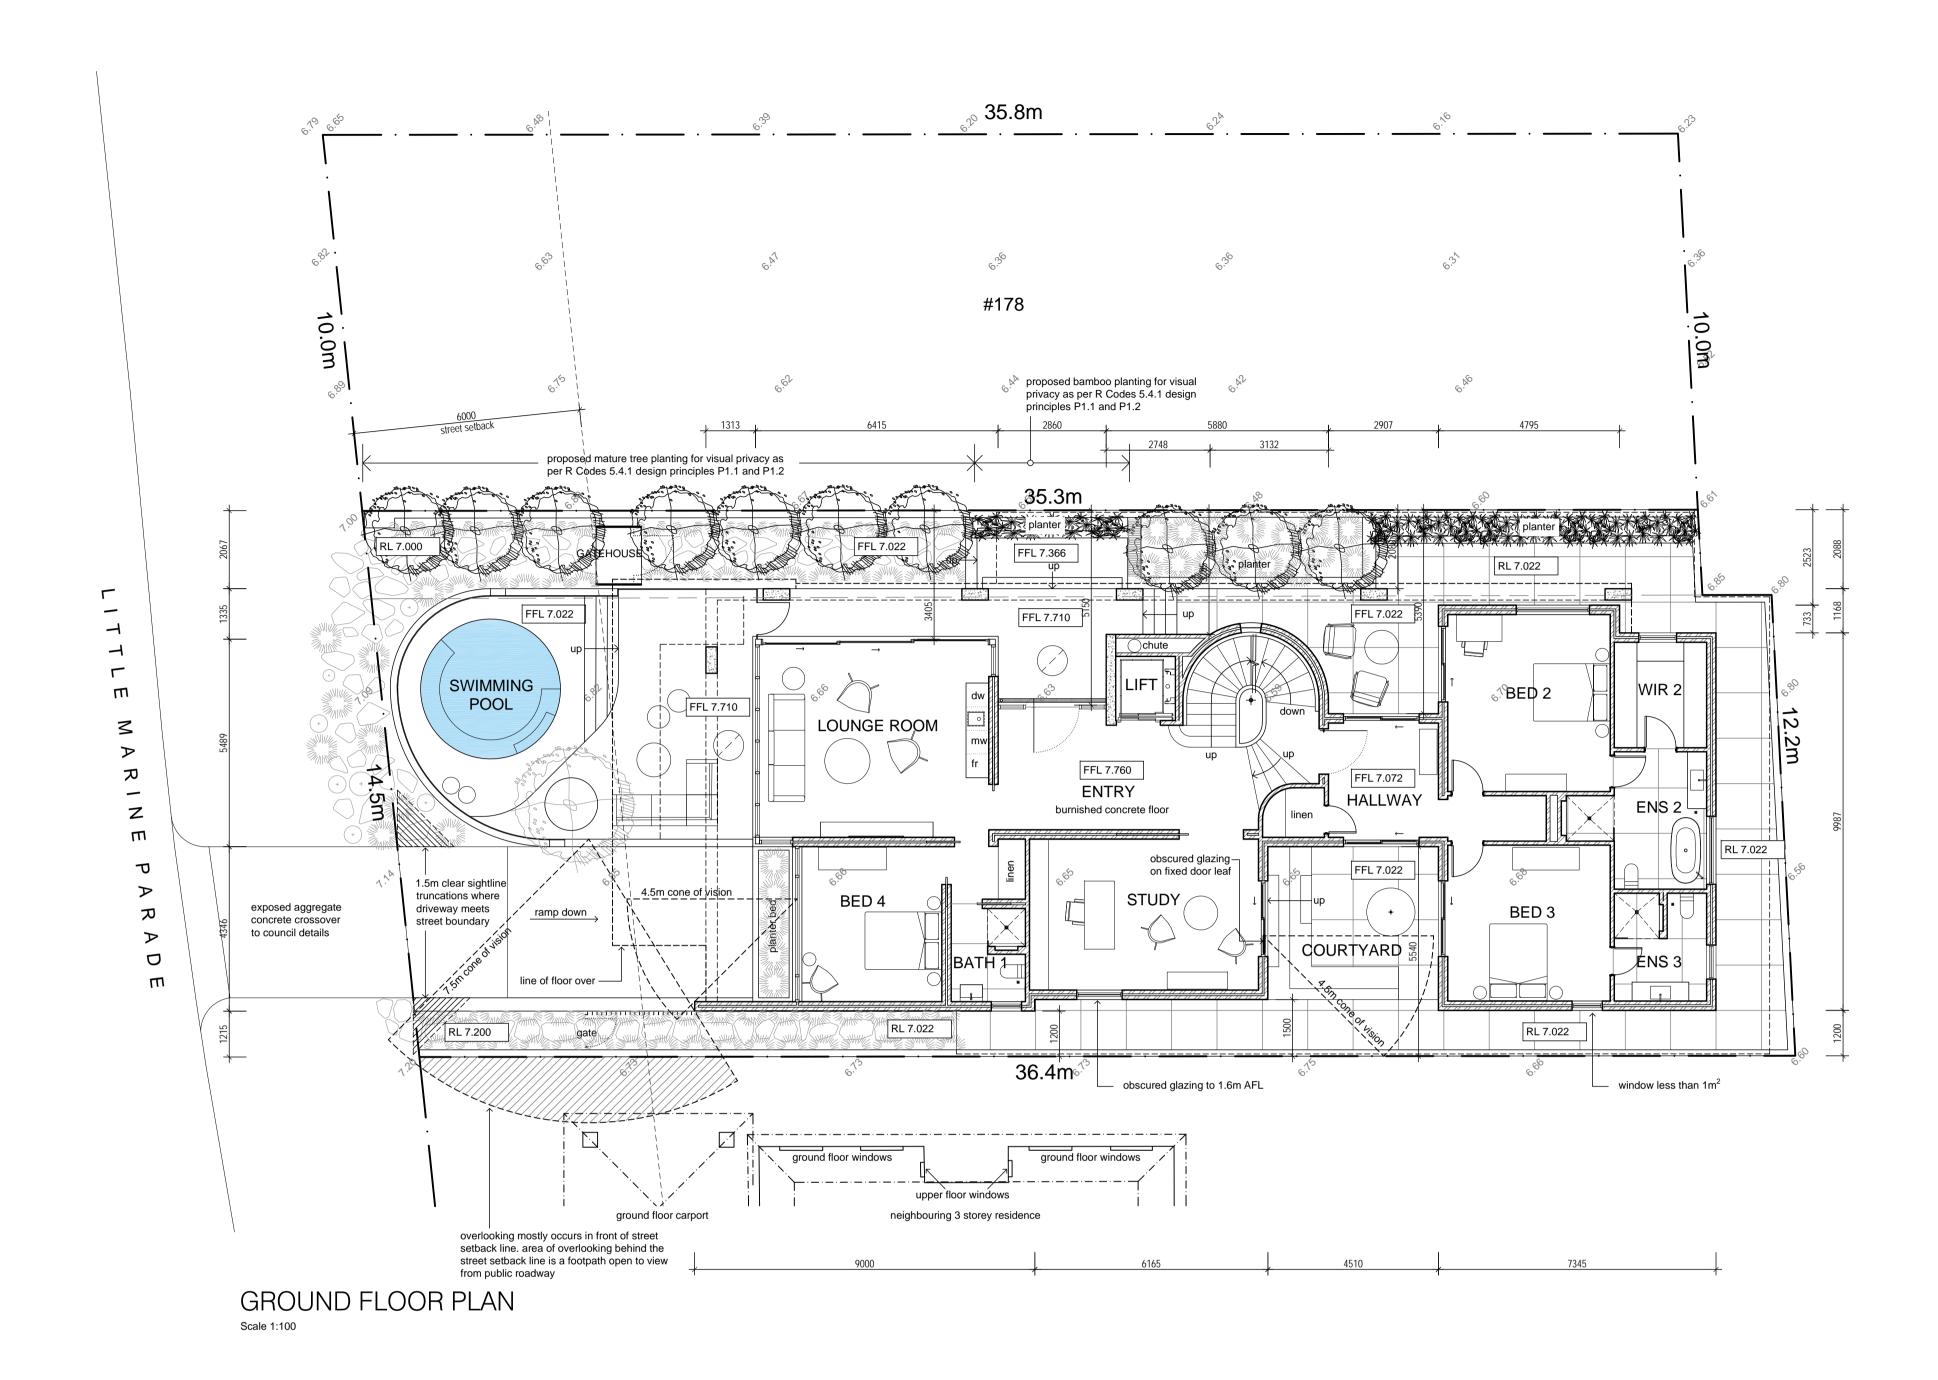

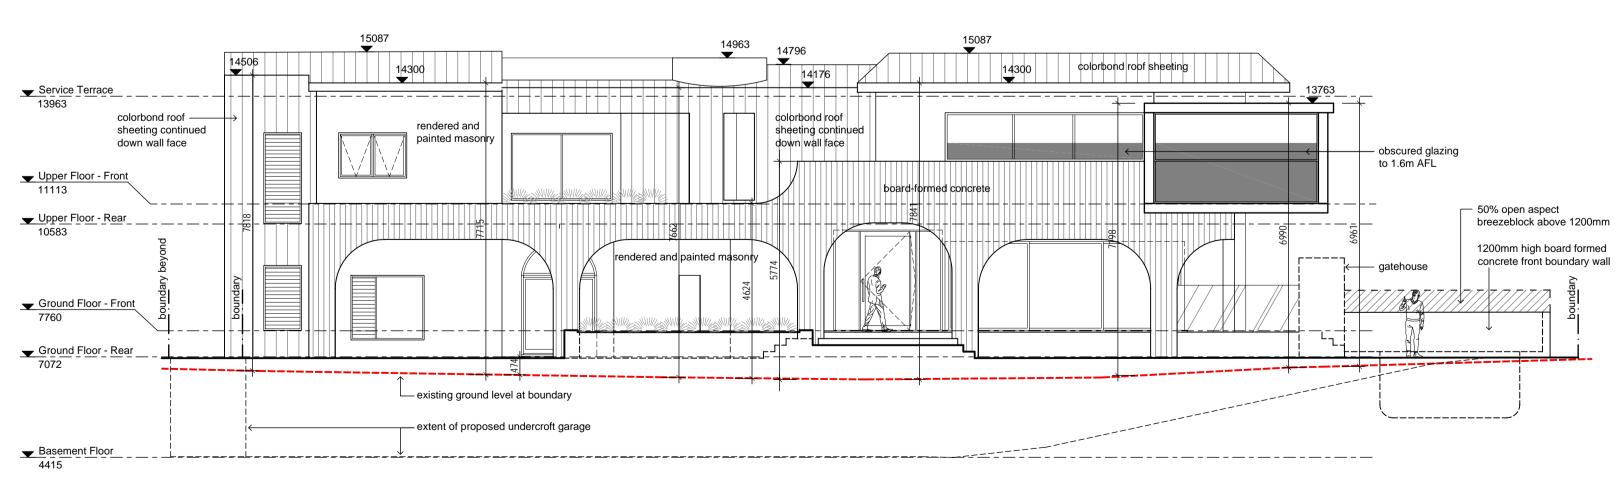






RL 6.830


proposed design level

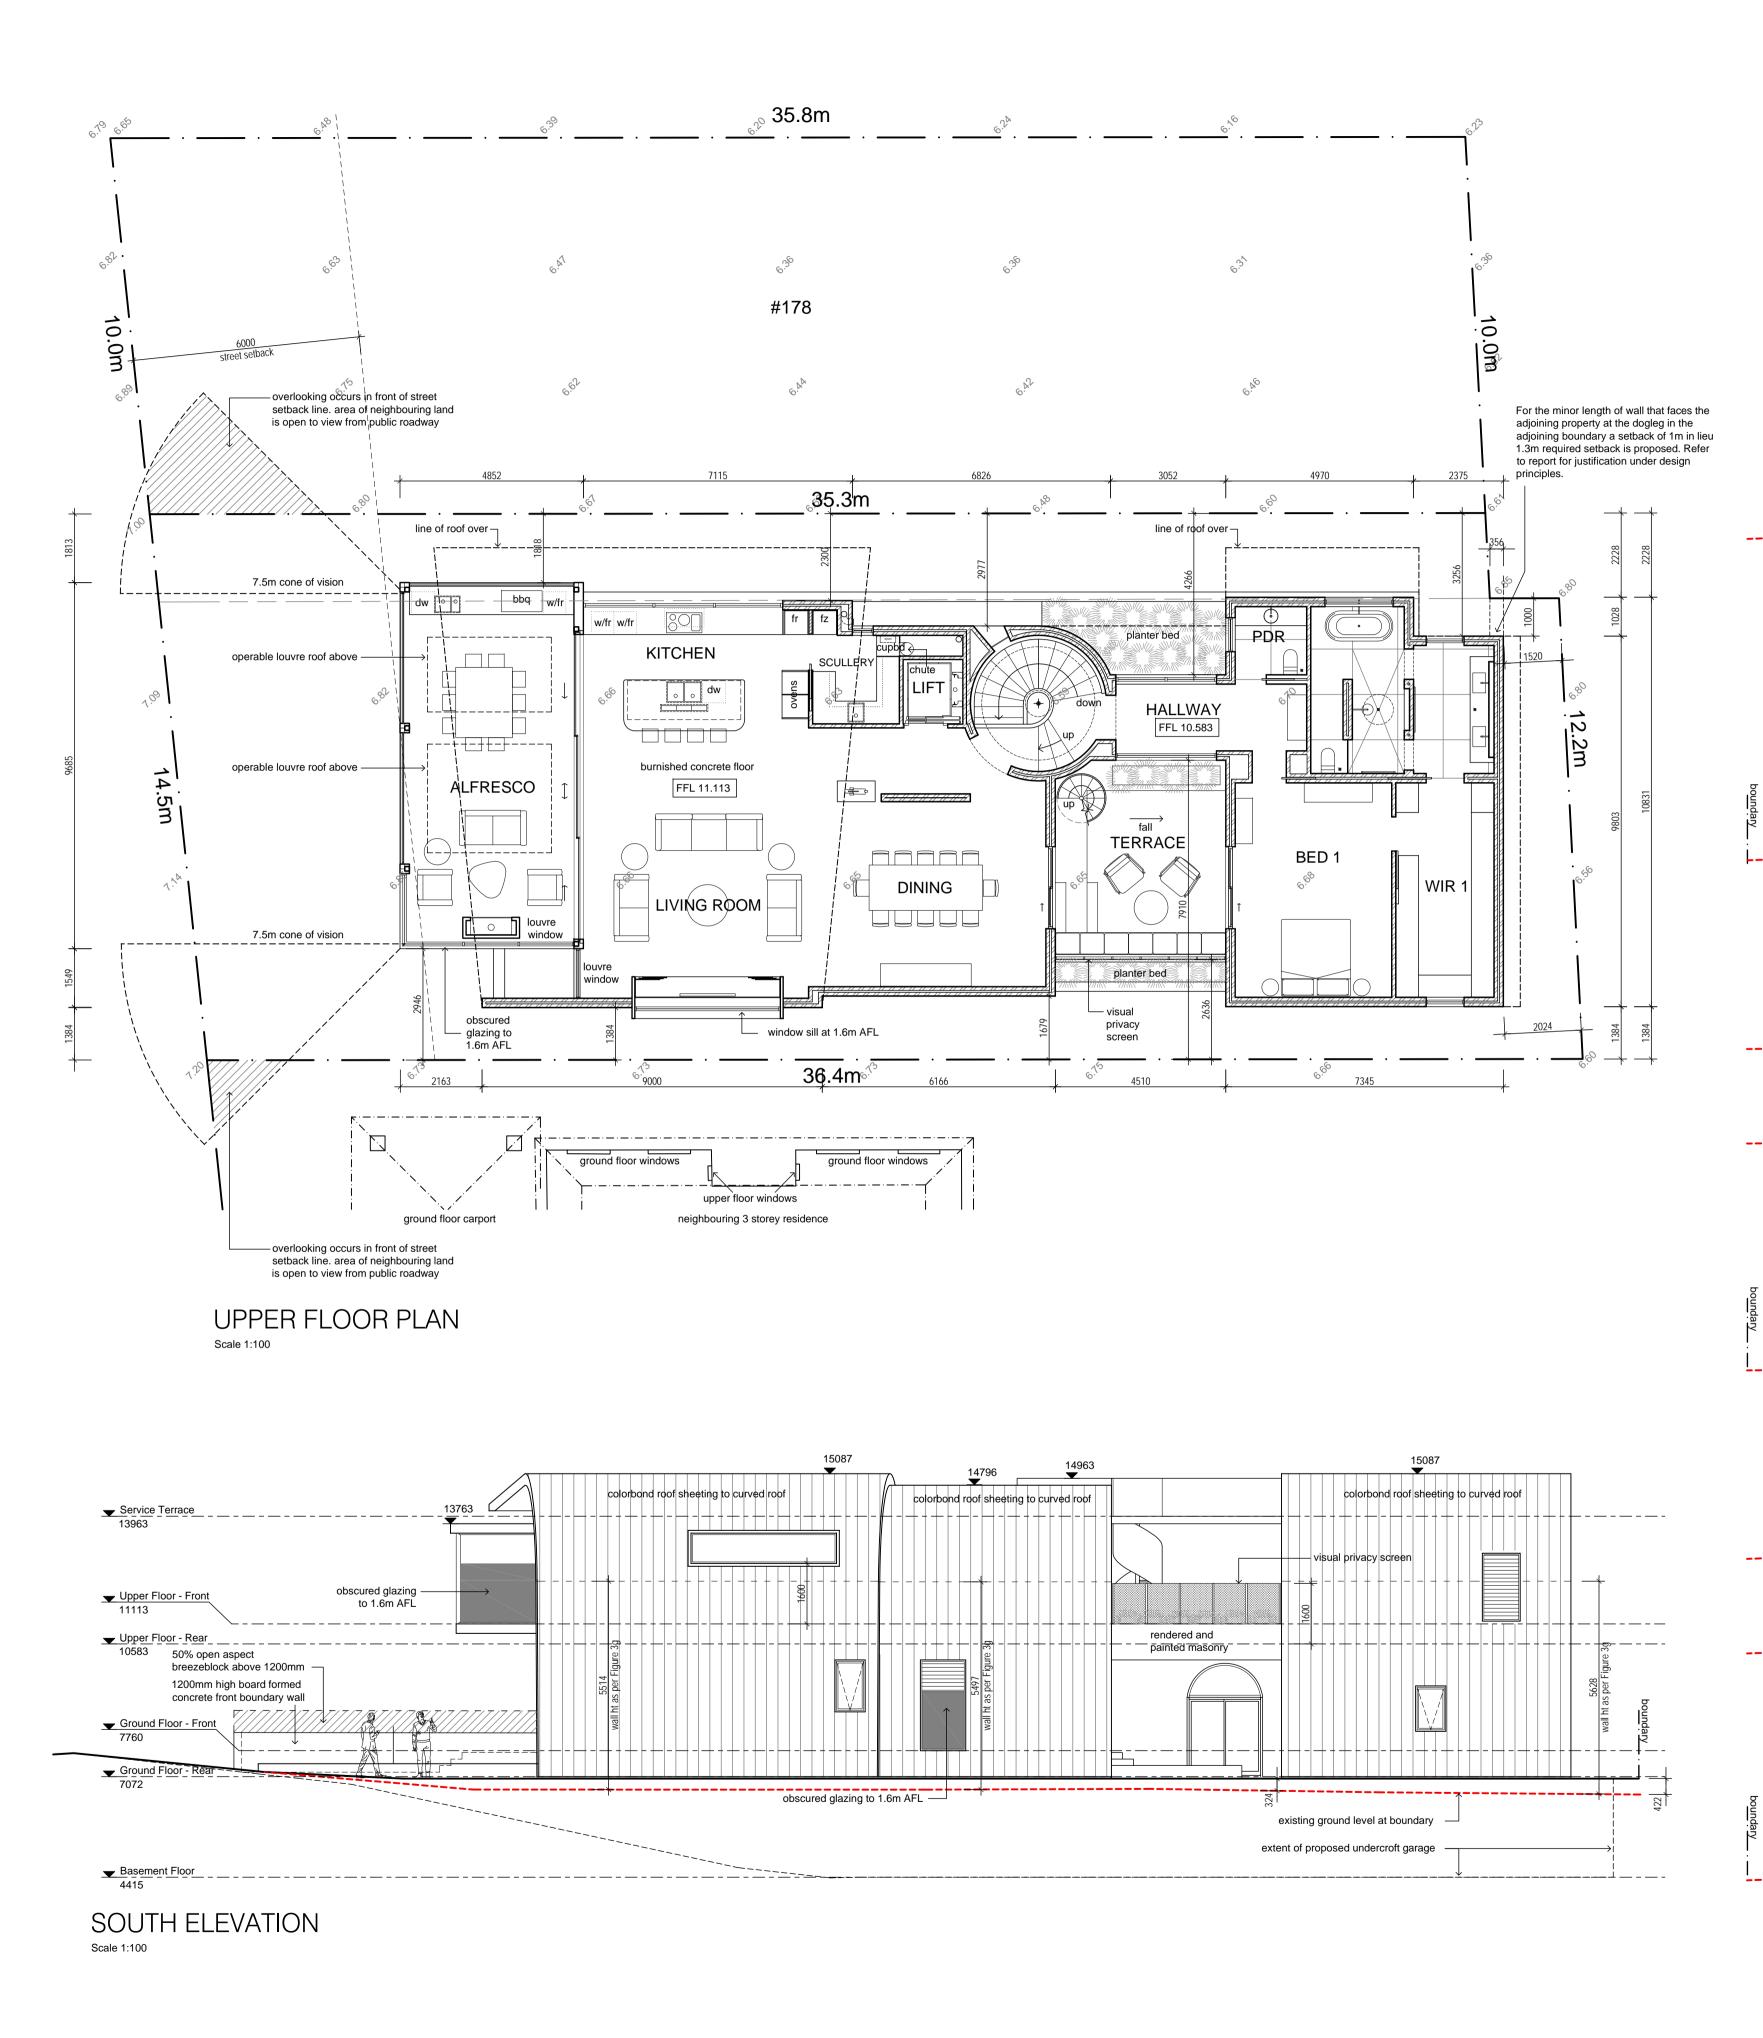

existing site level

RL 6.830

proposed design level

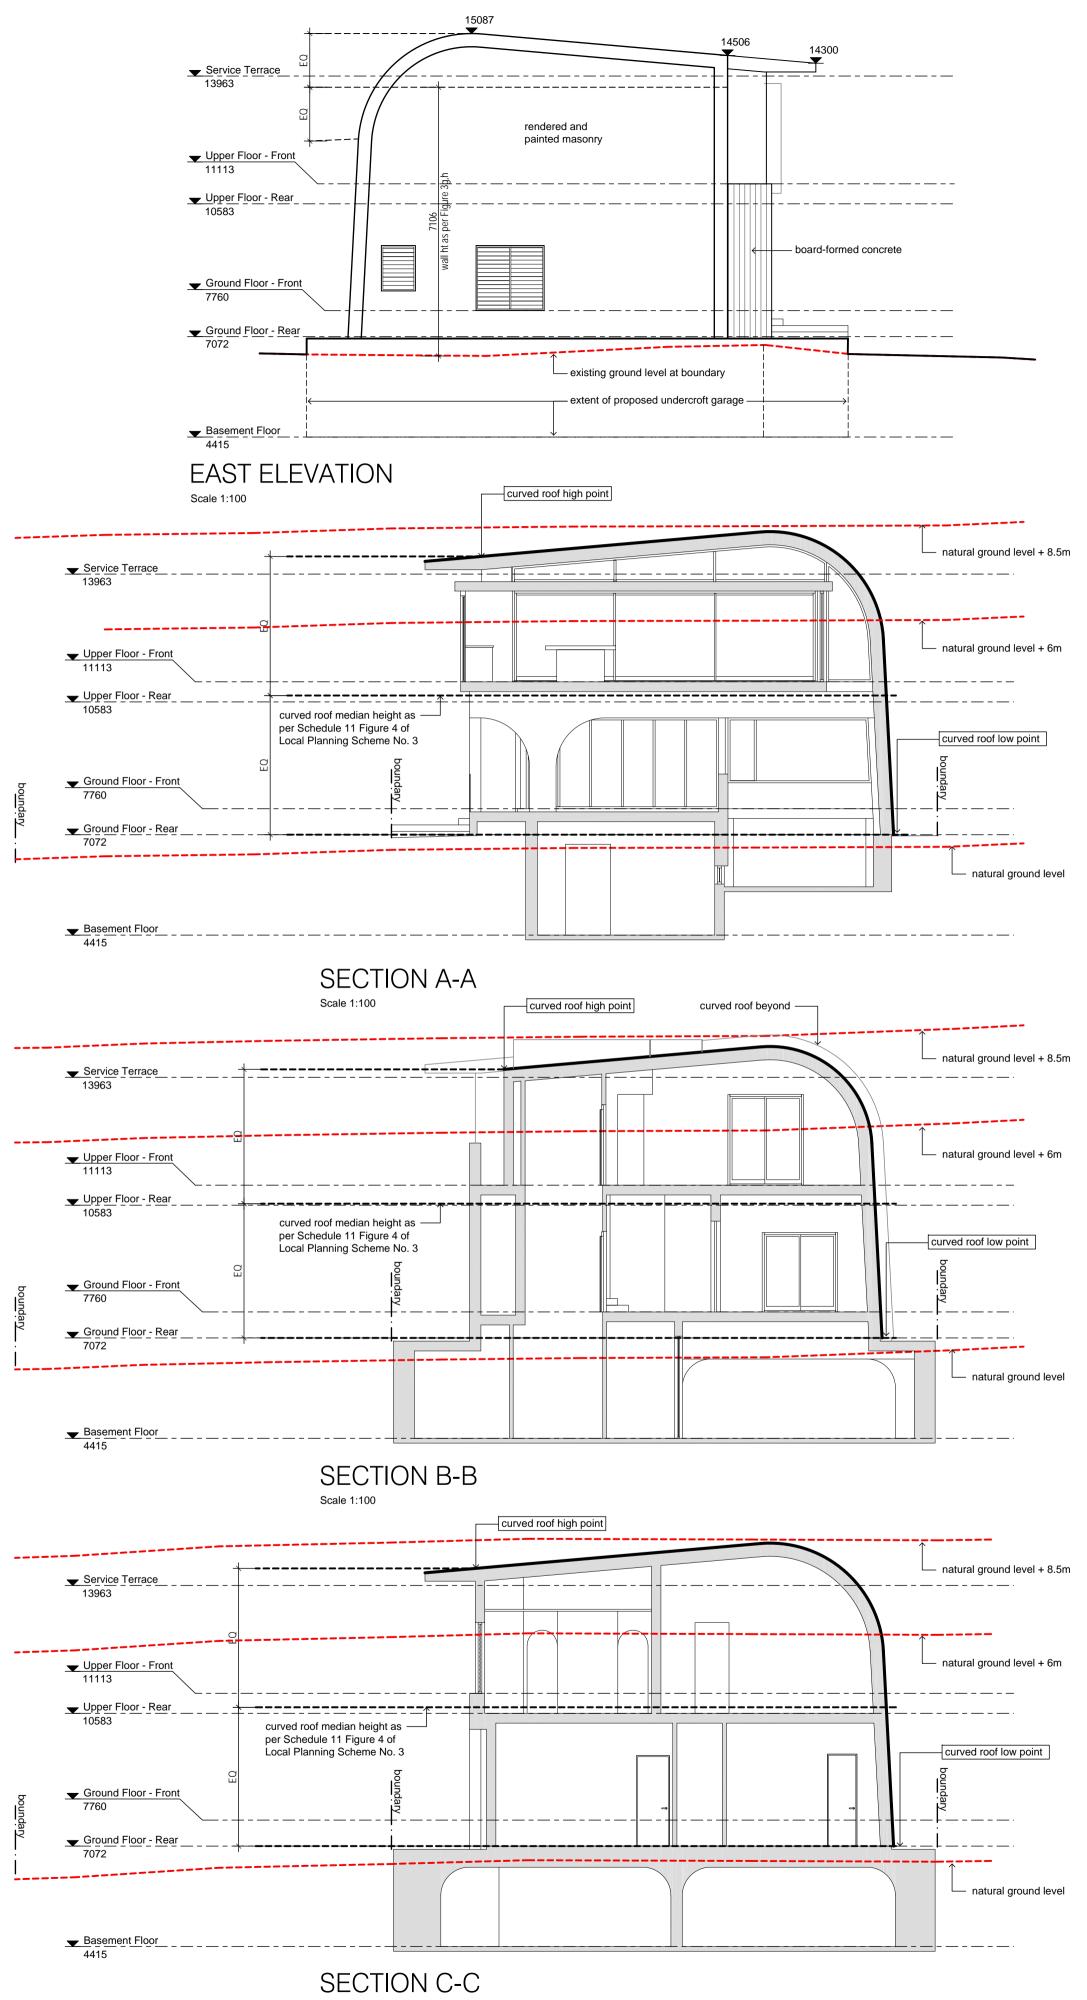

CARTER RESIDENCE

176 Little Marine Pde, Cottesloe







TOWN OF COTTESLOE

DATE RECEIVED

14/1/2021

