



The Town of Cottesloe does not warrant the accuracy of information in this publication and any person using or relying upon such information does so on the basis that the Town of Cottesloe shall bear no responsibility or liability whatsoever for any errors, faults, defects or omissions in the information.


Scale 1:625


Thursday, 6 February 2014








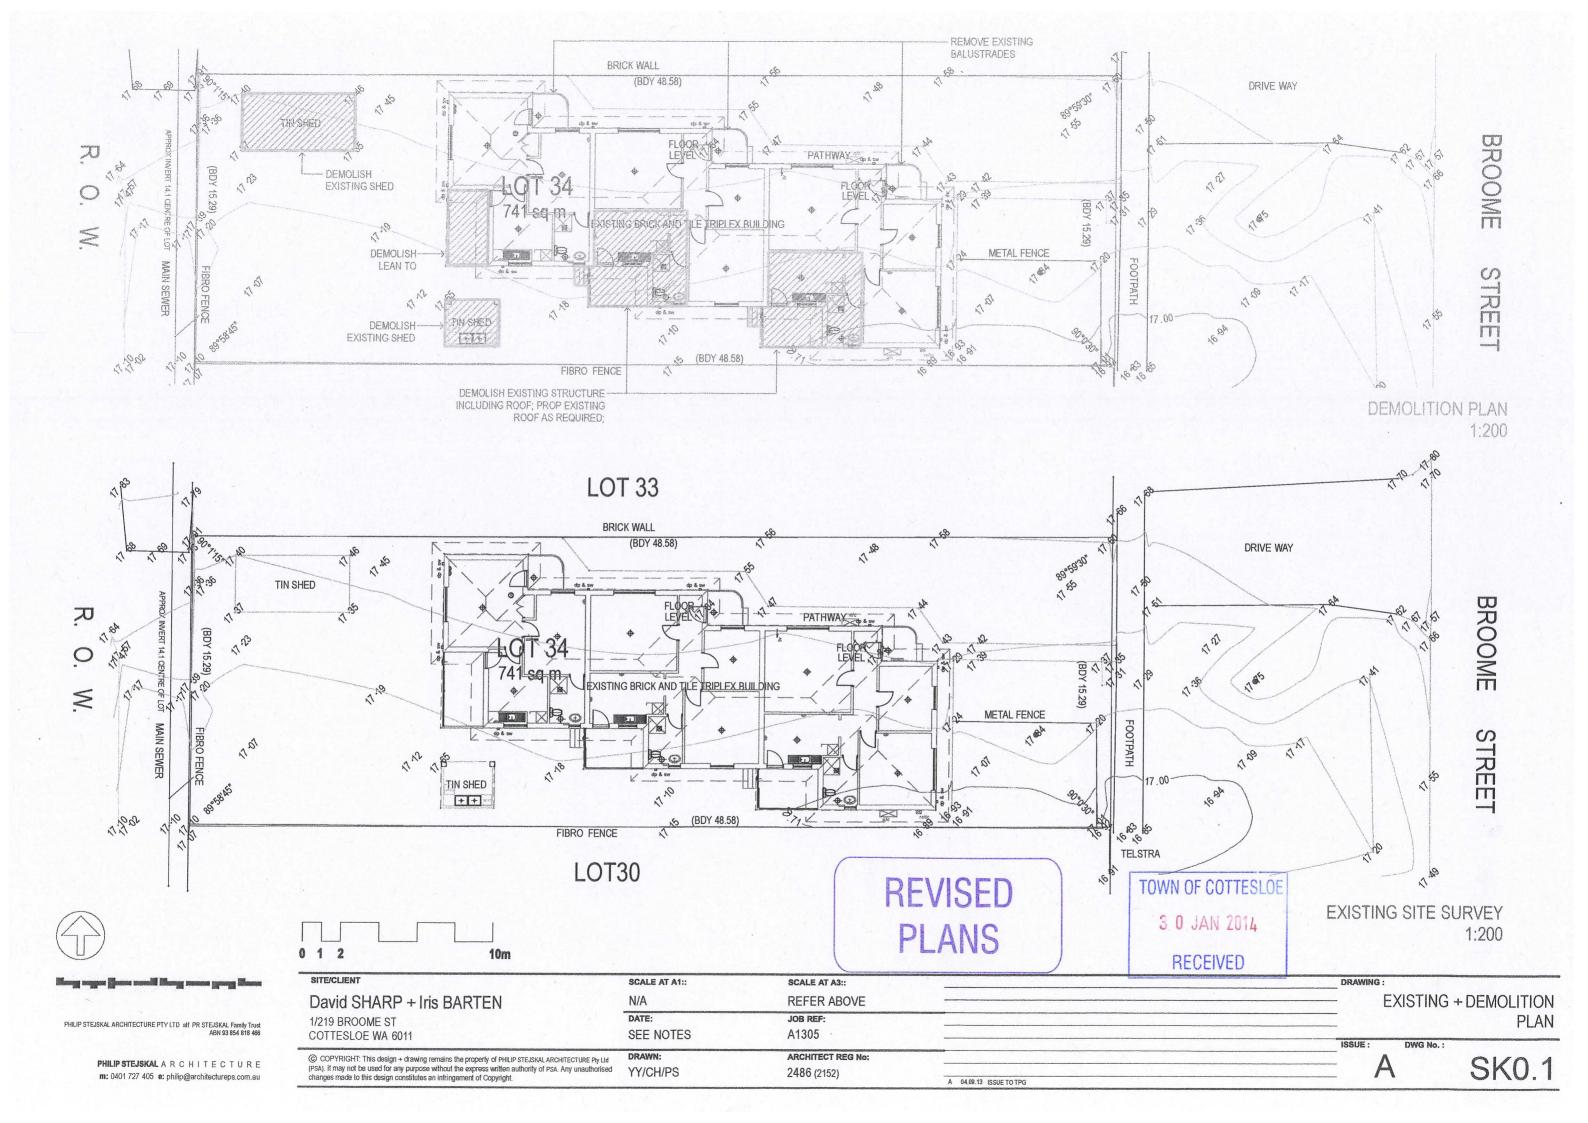


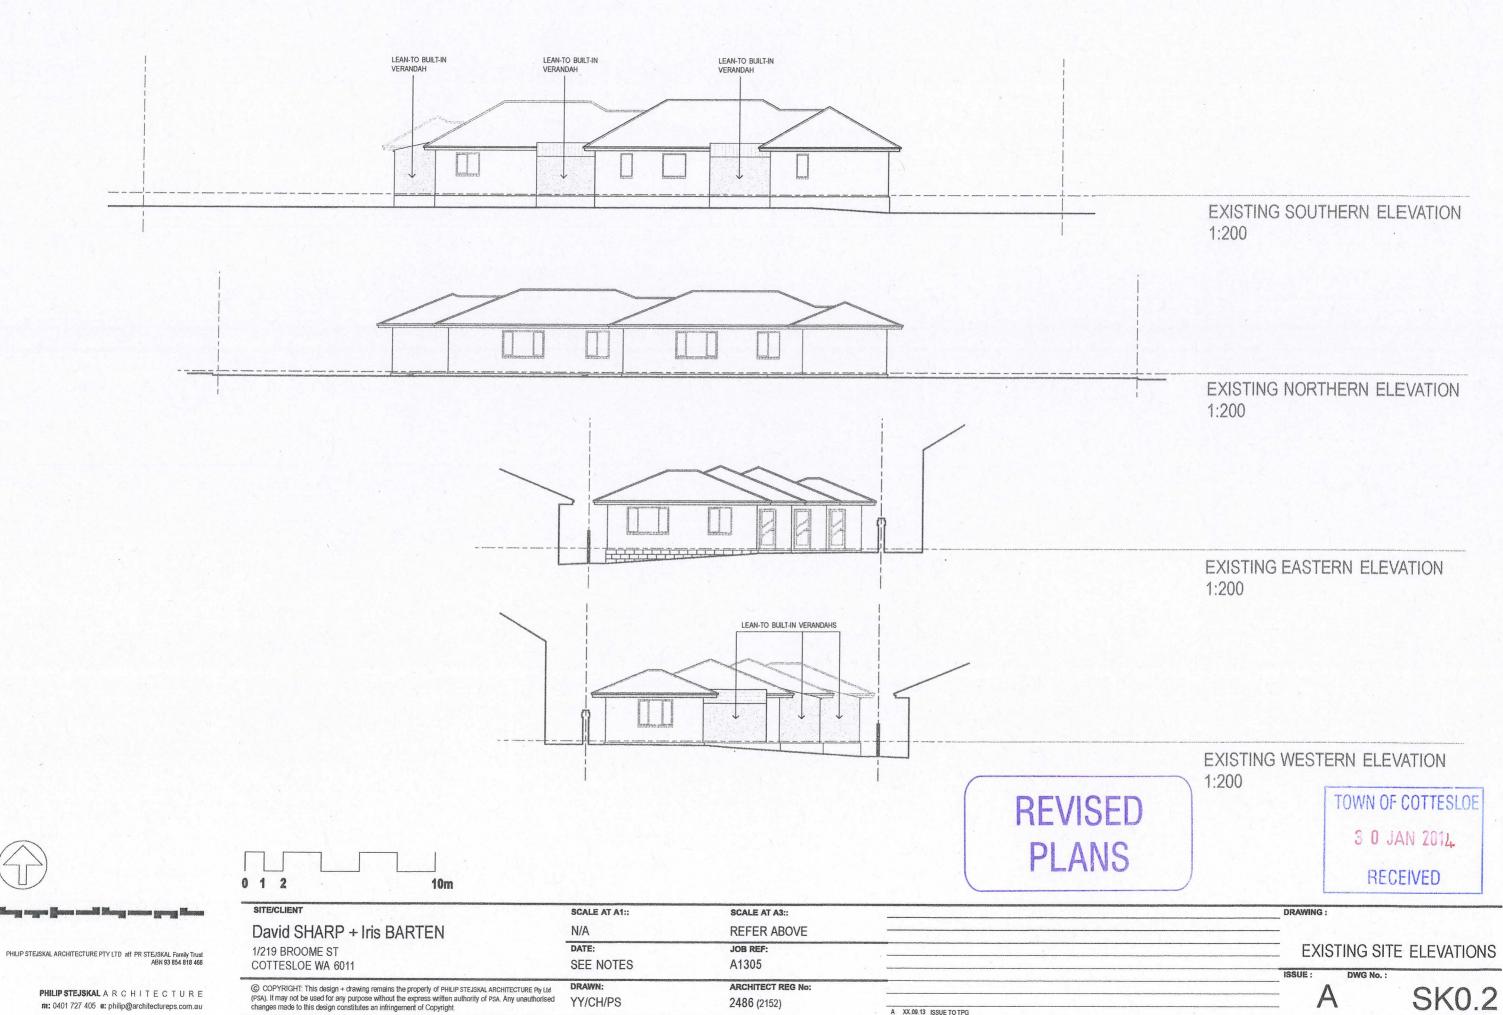

A XX.09.13 ISSUE TO TPG

PHILIP STEJSKAL ARCHITECTURE m: 0401 727 405 e: philip@architectureps.com.au

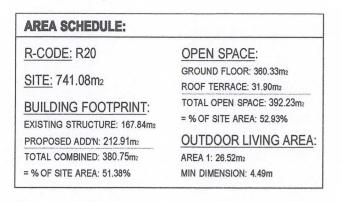


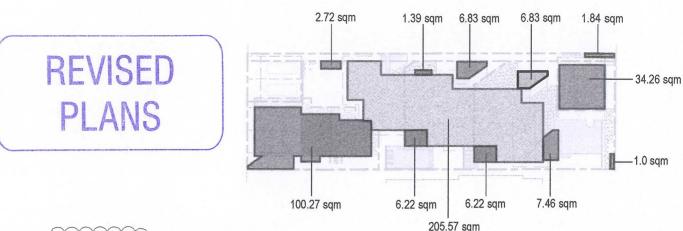

ISSUE :

H

SK1.0

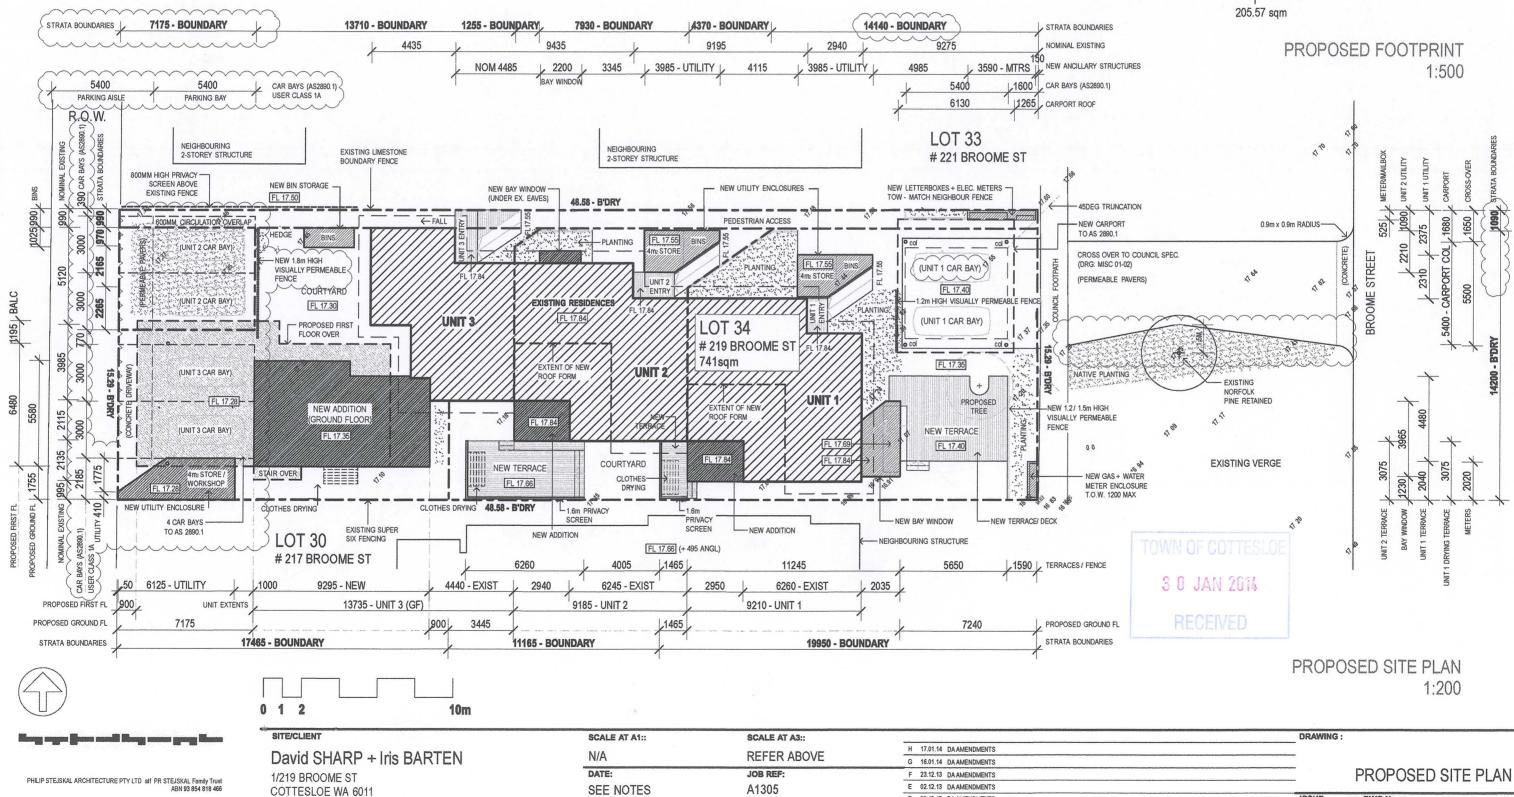

ARCHITECT REG No:

2486 (2152)

DRAWN

YY/CH/PS

© COPYRIGHT: This design + drawing remains the property of PHILIP STEUSKAL ARCHITECTURE Pty Ltd.

(PSA). It may not be used for any purpose without the express written authority of PSA. Any unauthorised changes made to this design constitutes an infringement of Copyright.

PHILIP STEJSKAL A R C H I T E C T U R E


m: 0401 727 405 e: philip@architectureps.com.au


D 09.10.13 DA AMENDMENTS


C 03.10.13 DA AMENDMENTS


B 04.09.13 RE-ISSUE TO TPG


A 02.09.13 ISSUE TO TPG

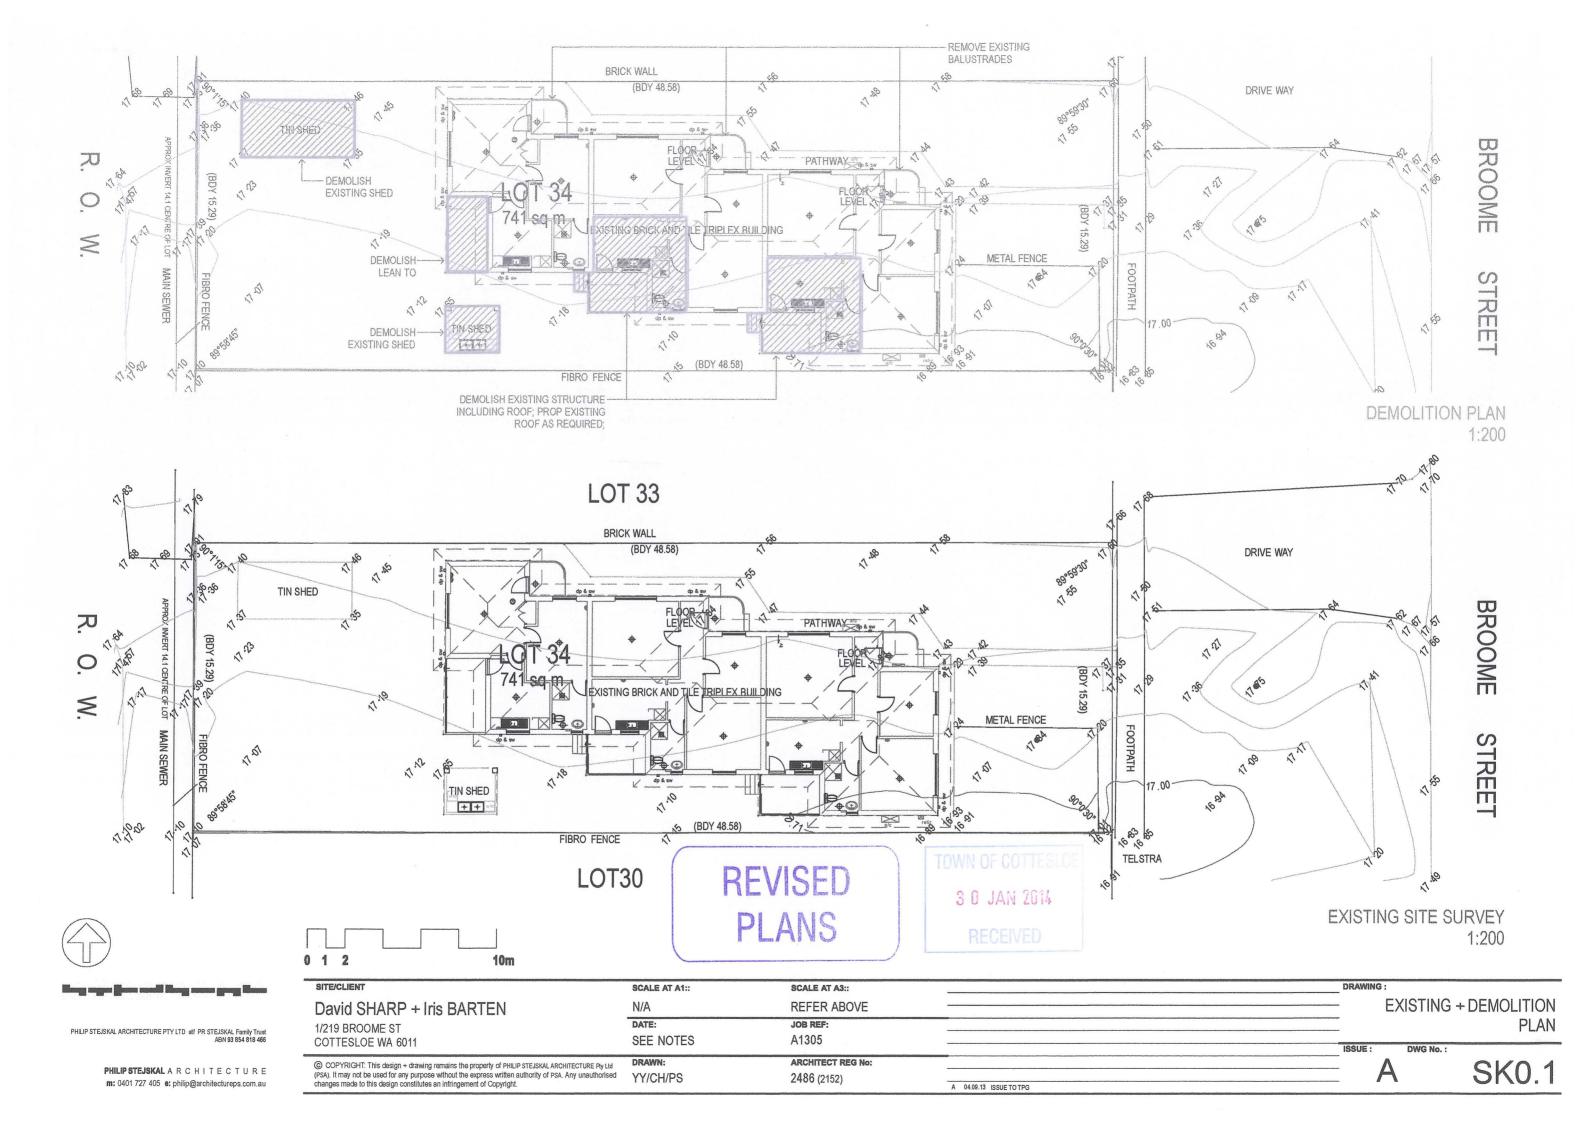


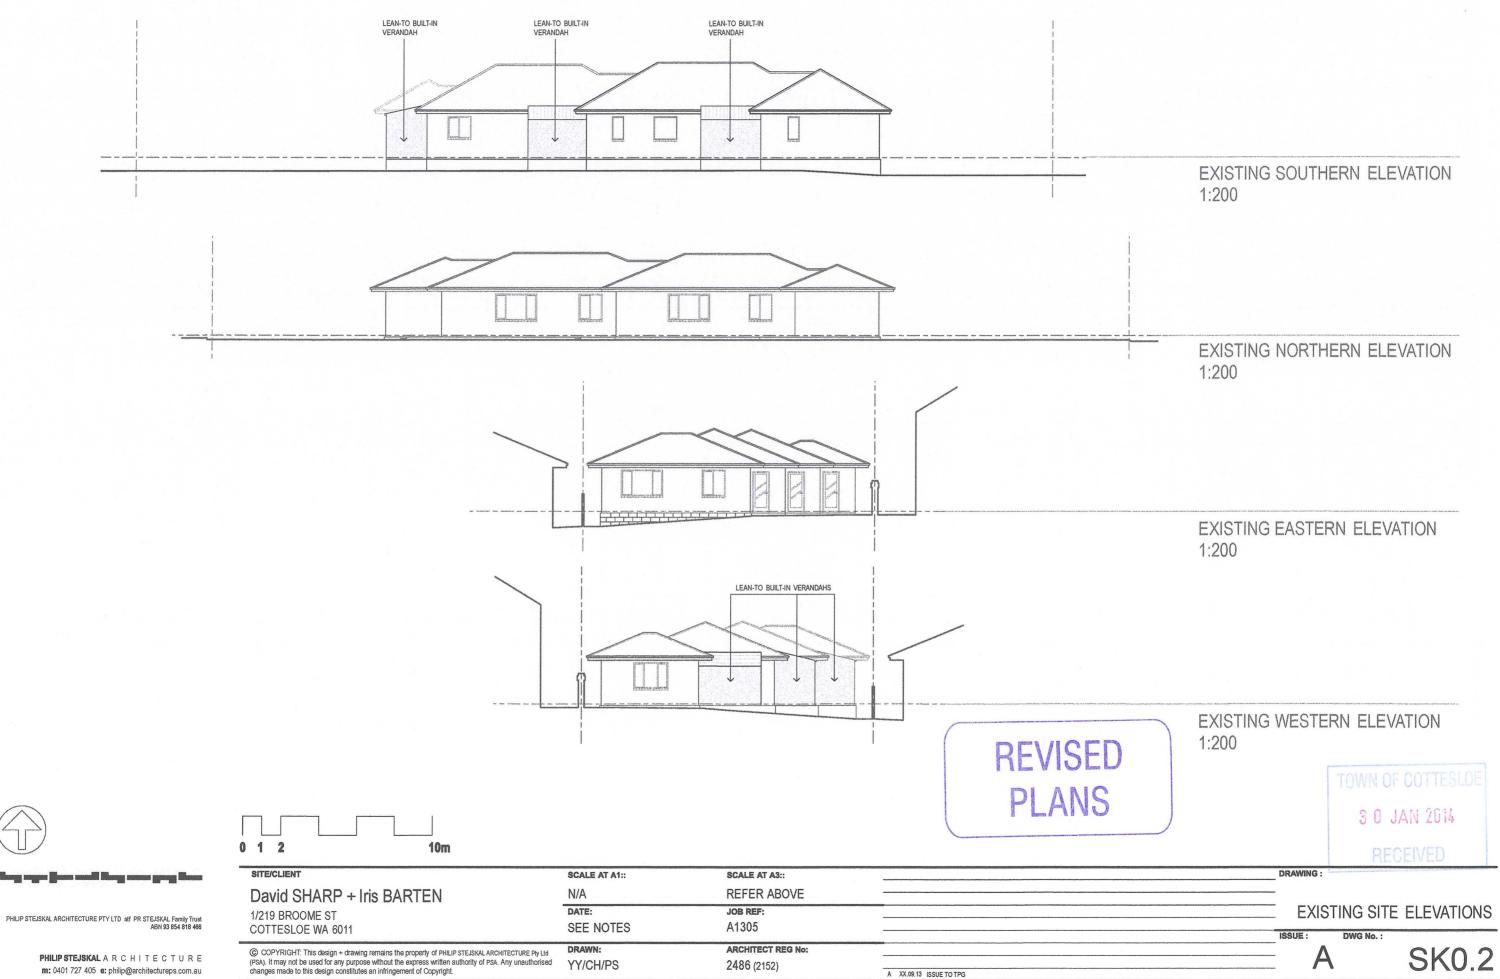


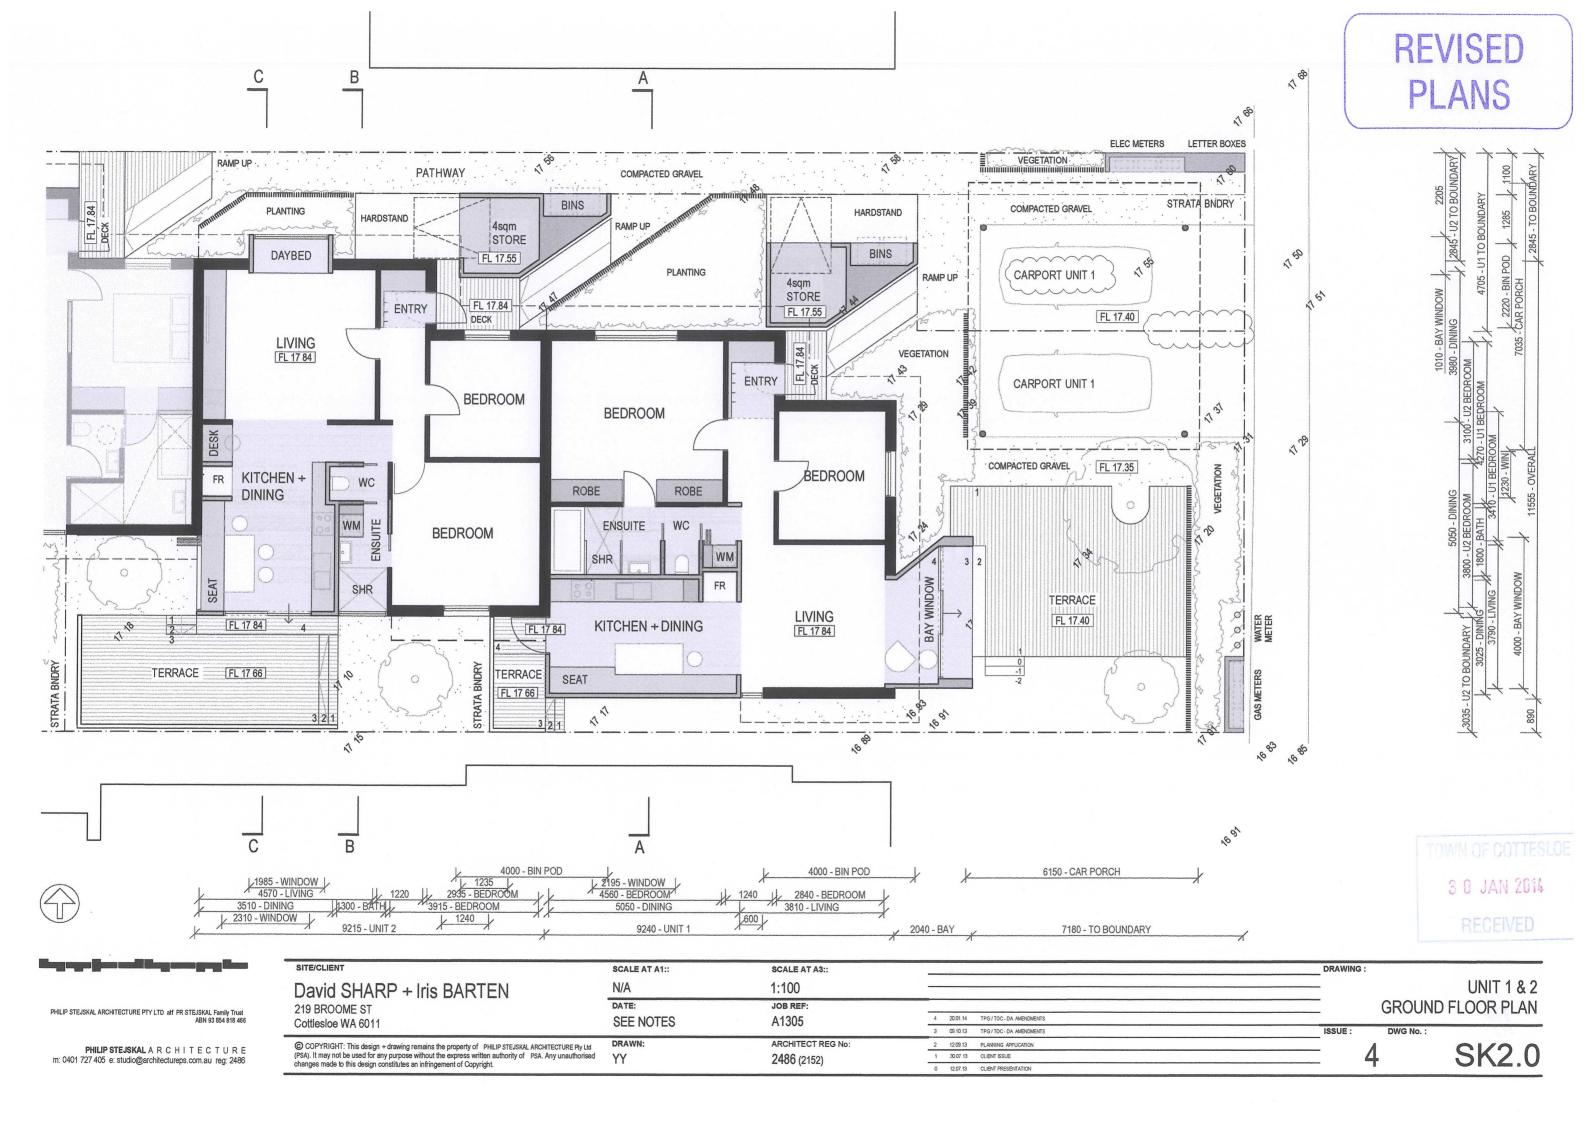

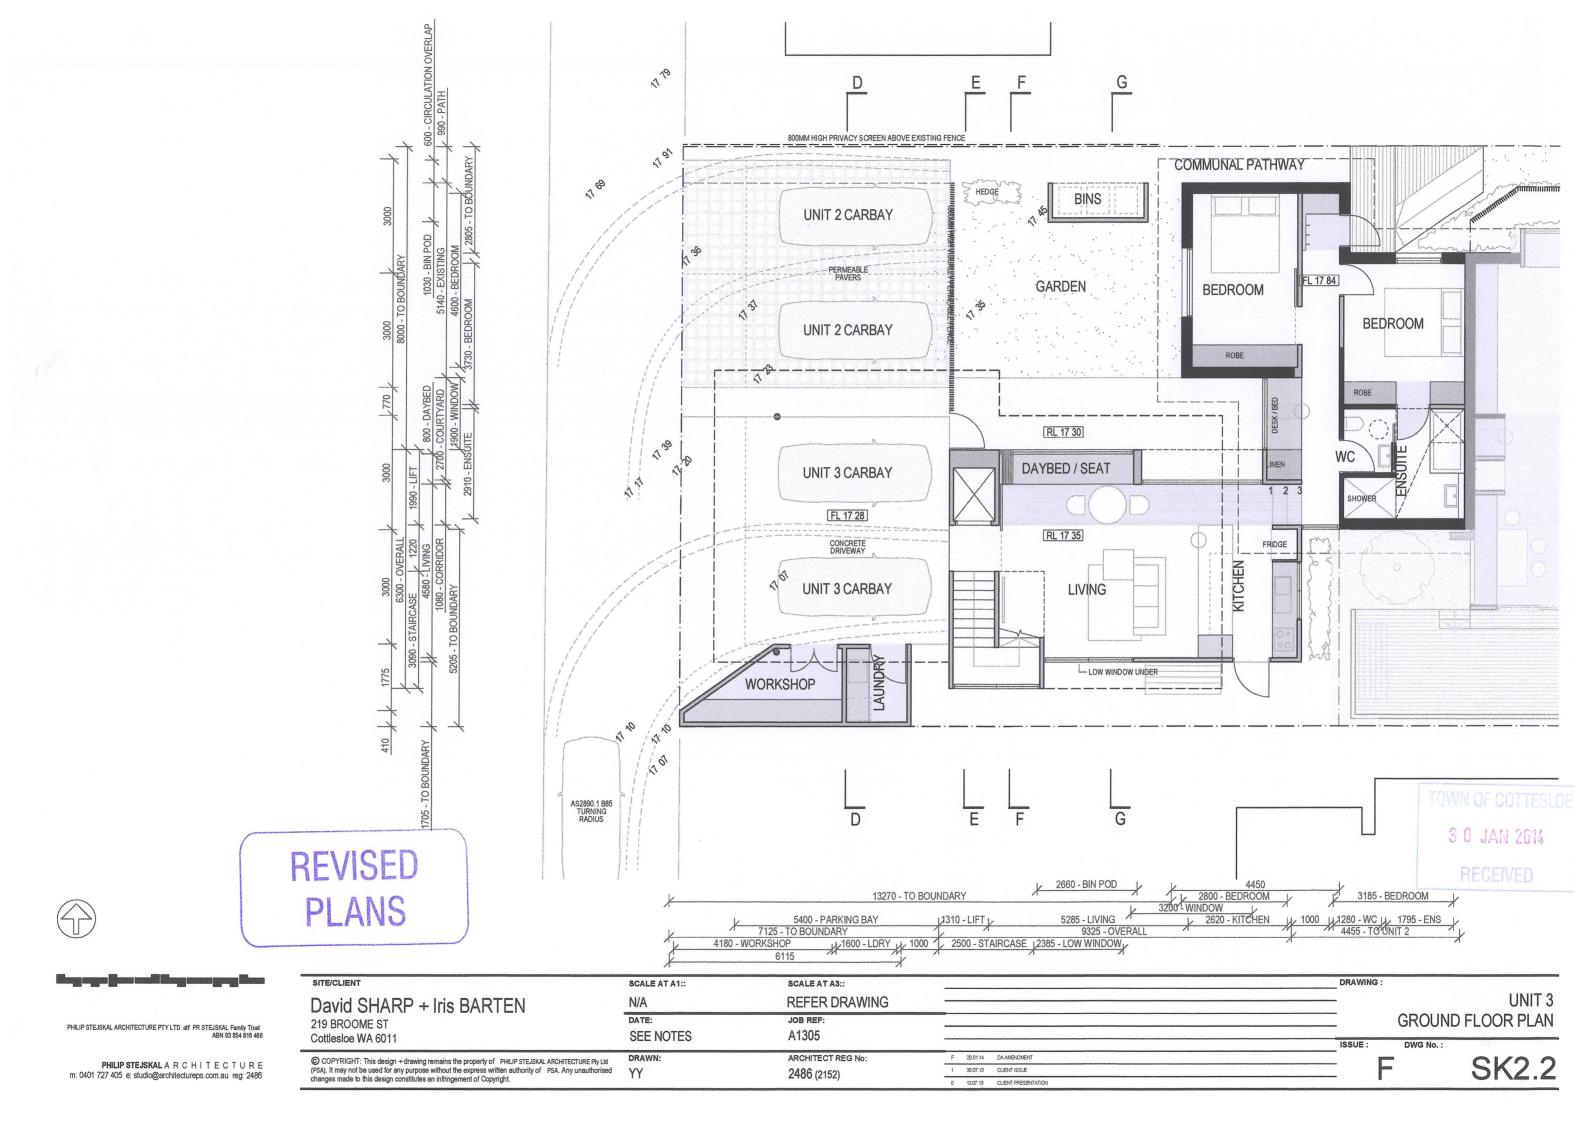

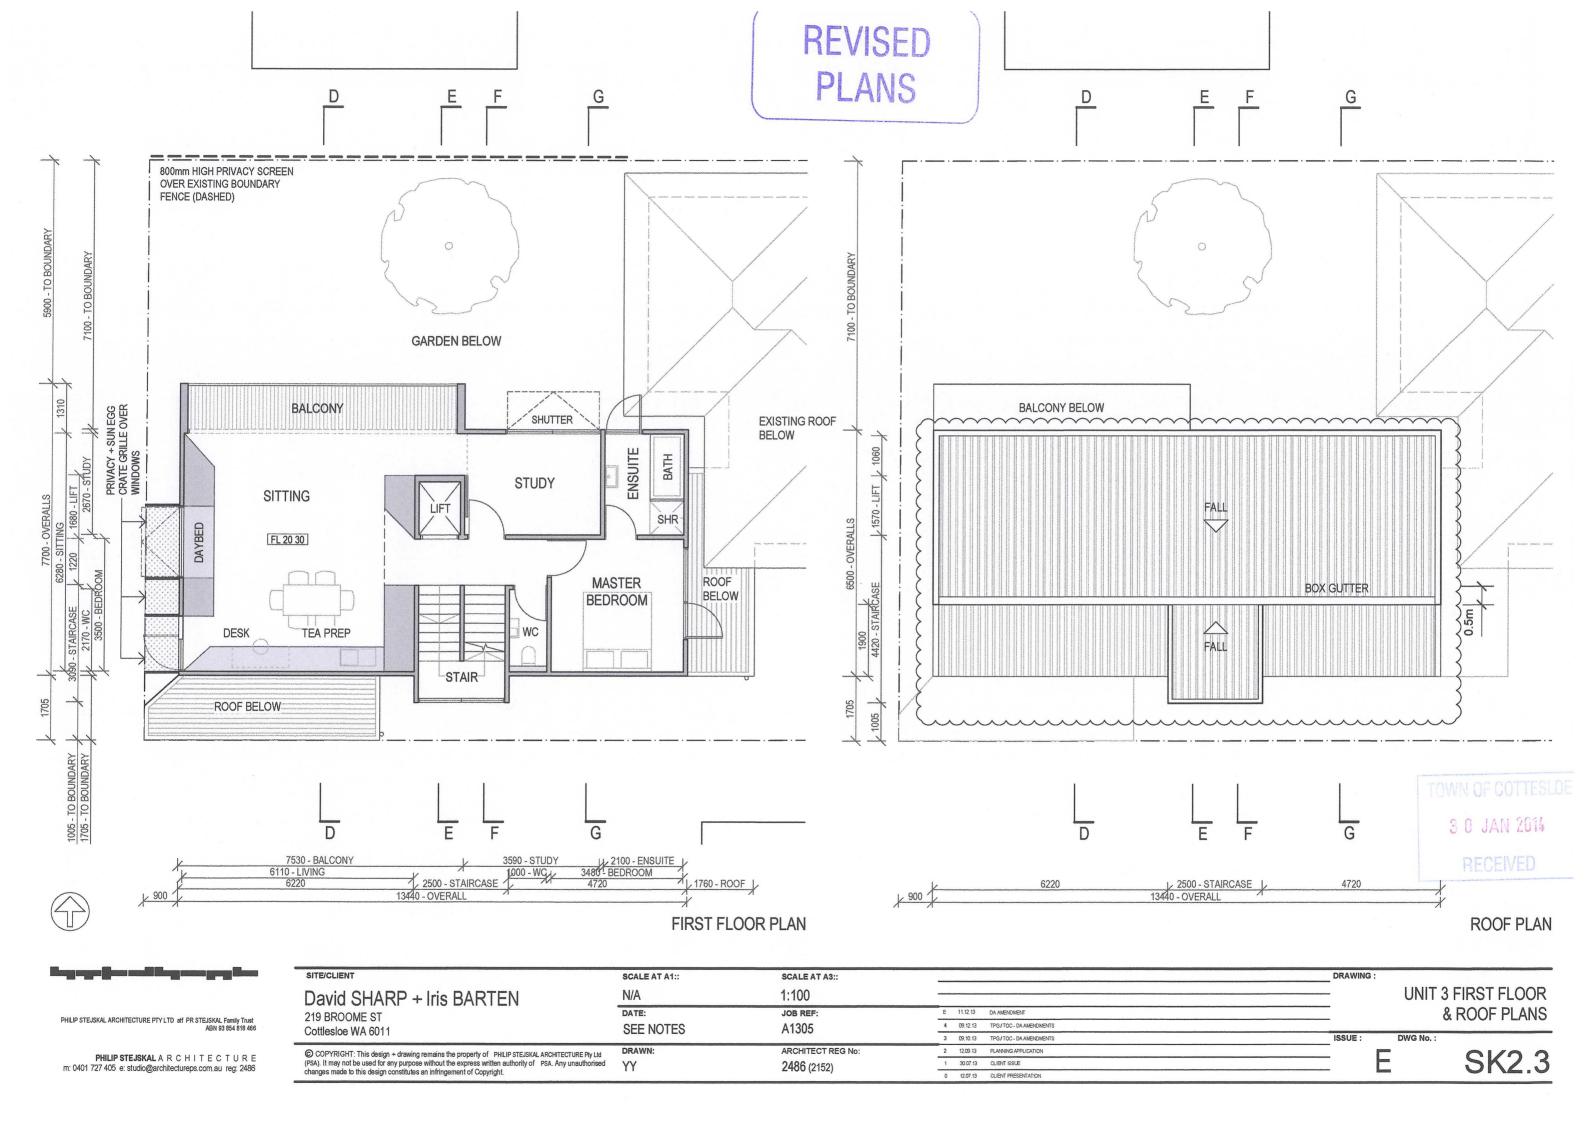

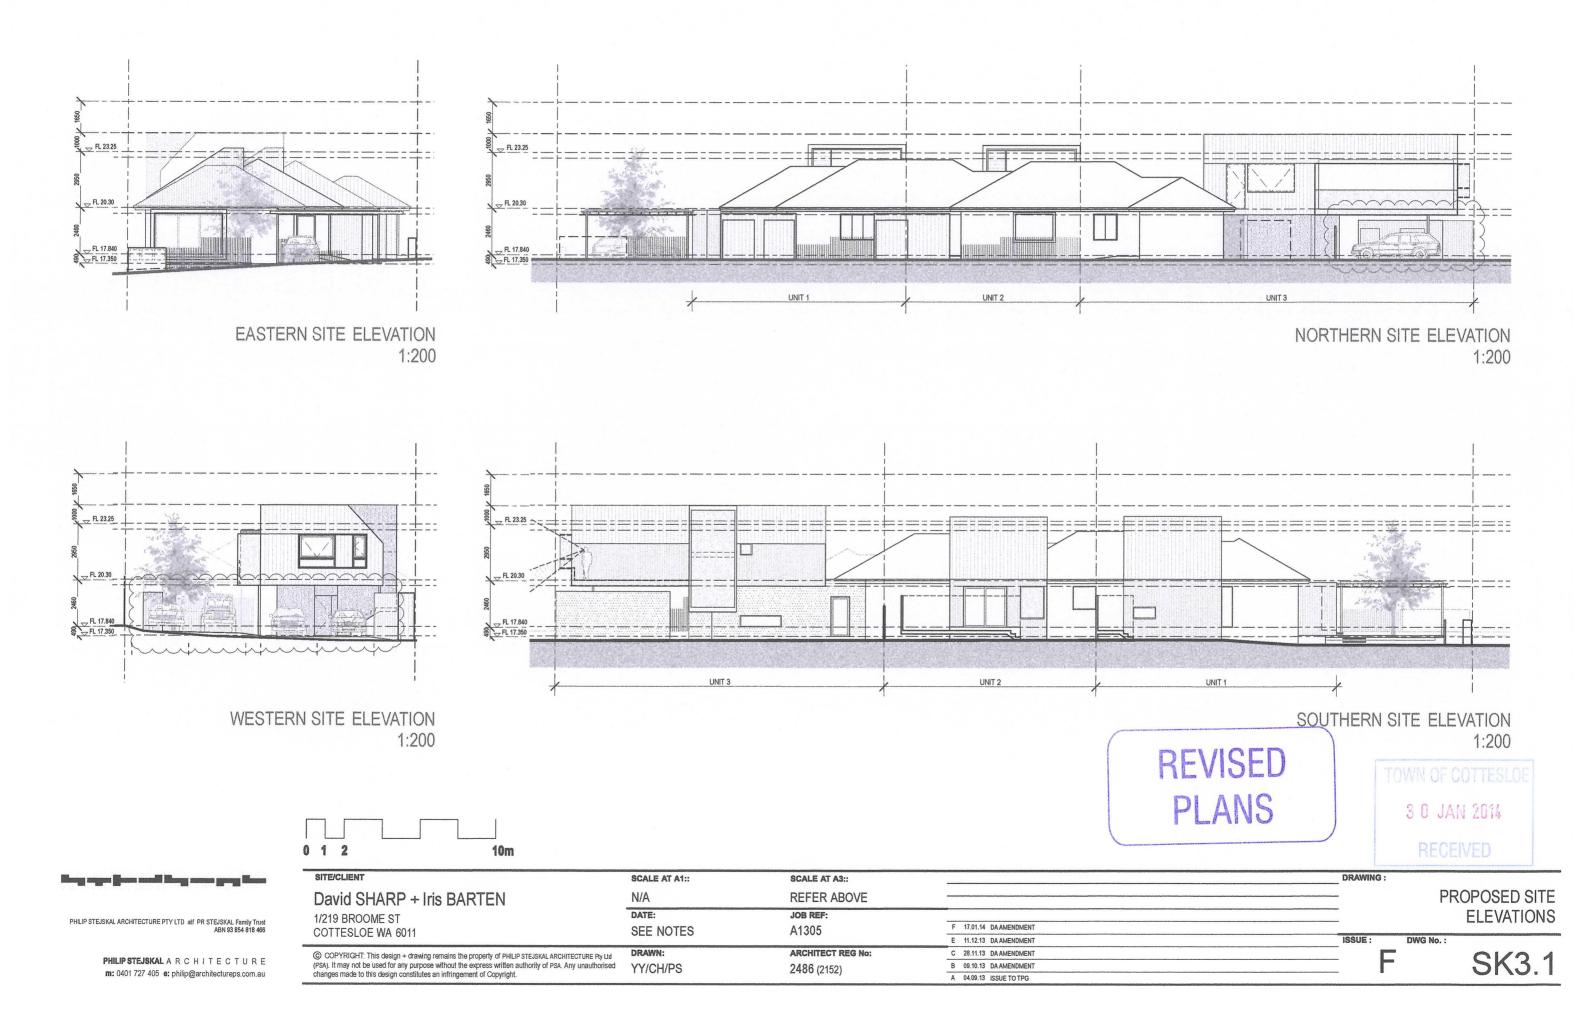

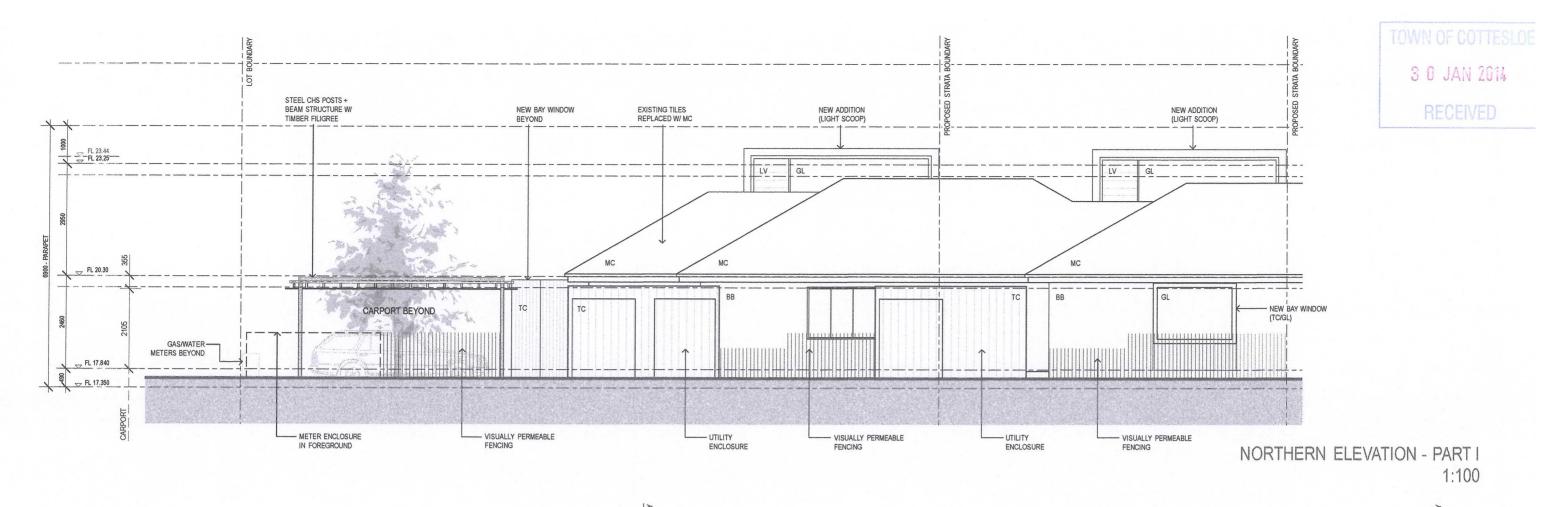

SCALE AT A3::


JOB REF:

A1305

2486 (2152)

REFER ABOVE

ARCHITECT REG No:

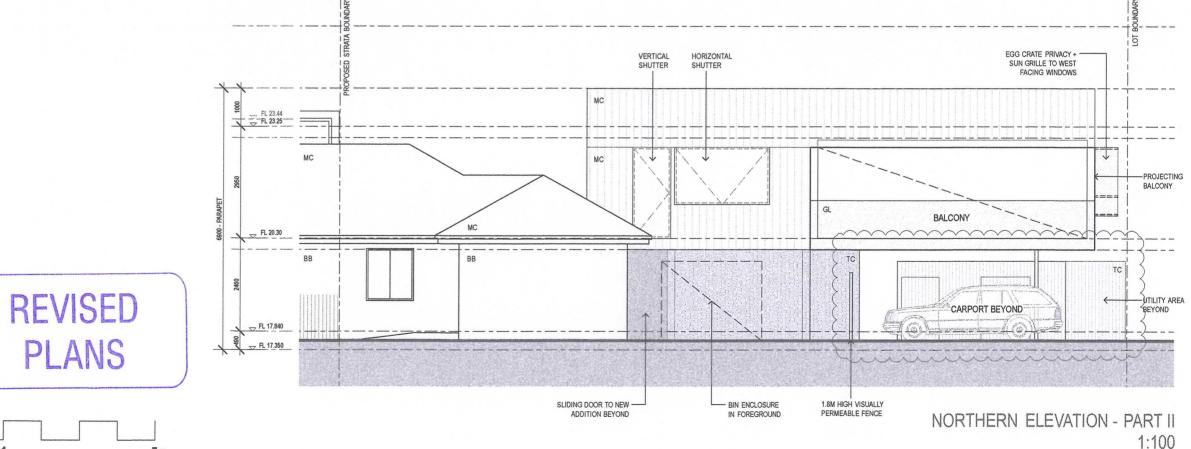

F 17.01.14 DA AMENDMENT

E 11.12.13 DA AMENDMENT

C 28.11.13 DA AMENDMENT

B 09.10.13 DA AMENDMENT

A 04.09.13 ISSUE TO TPG

DRAWING:

ISSUE :

NORTH ELEVATION

SK3.2

MATERIALS / FINISHES LEGEND

BB GL LV MC POL TC PAINTED BAGGED BRICKWORK GLAZING
OPERABLE LOUVRES
PROFILED METAL SHEETING
POLYCARBONATE CLADDING

VERTICAL TIMBER CLADDING

PHILIP STEJSKAL ARCHITECTURE PTY LTD atf PR STEJSKAL Family Trust ABN 93 854 818 466

PHILIP STEJSKAL A R C H I T E C T U R E m: 0401 727 405 e: philip@architectureps.com.au 0 .5 1

1/219 BROOME ST

COTTESLOE WA 6011

David SHARP + Iris BARTEN

5m

© COPYRIGHT: This design + drawing remains the property of PHILIP STEJSKAL ARCHITECTURE Pty Ltd

(PSA). It may not be used for any purpose without the express written authority of PSA. Any unauthorised changes made to this design constitutes an infringement of Copyright.

SCALE AT A1::


SEE NOTES


N/A


DATE:

DRAWN:

YY/CH/PS

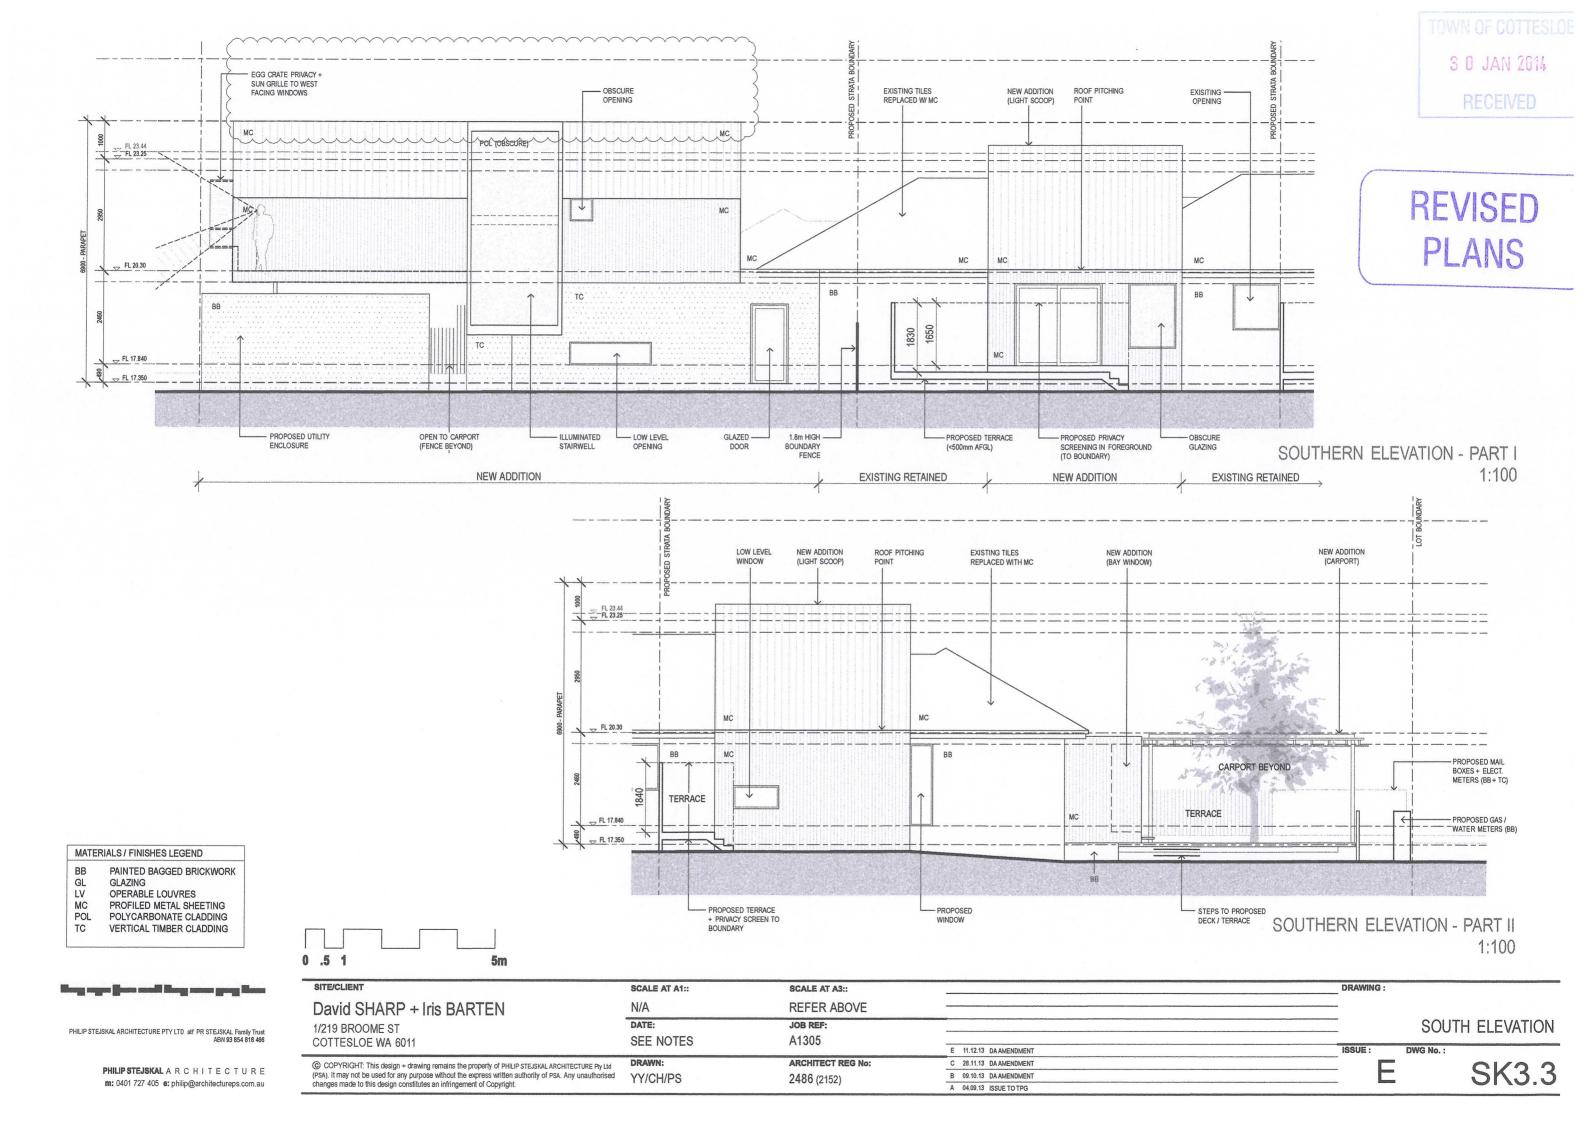

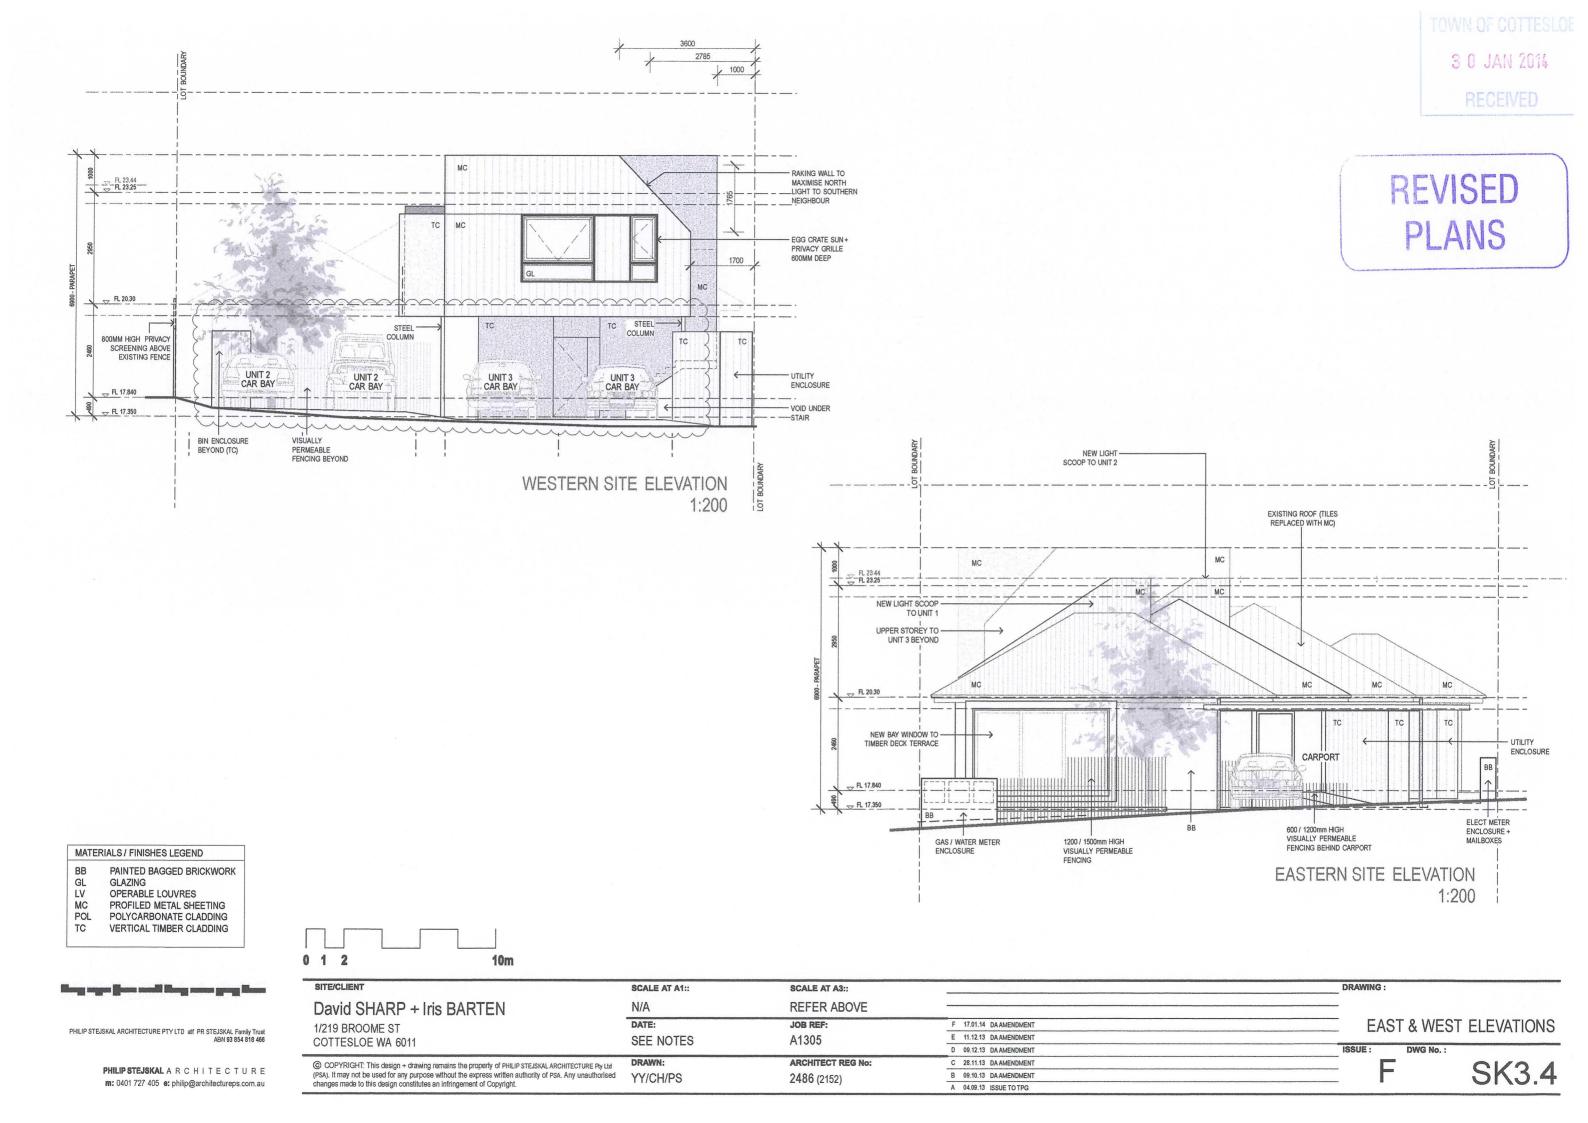

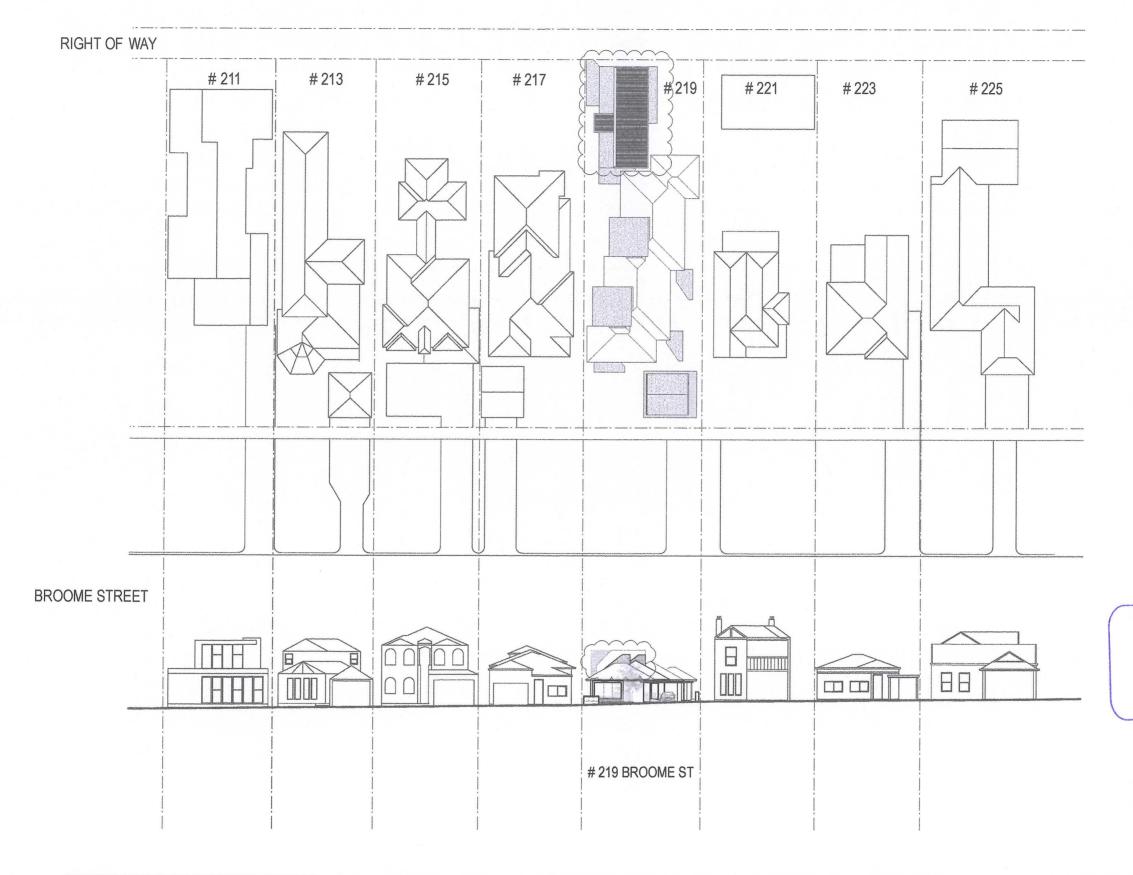

PHILIP STEJSKAL ARCHITECTURE PTY LTD aff PR STEJSKAL Family Trust ABN 93 854 818 466

PHILIP STEJSKAL A R C H I T E C T U R E m: 0401 727 405 e: philip@architectureps.com.au David SHARP + Iris BARTEN 1/219 BROOME ST COTTESLOE WA 6011

SITE/CLIENT

© COPYRIGHT: This design + drawing remains the property of PHILIP STEJSKAL ARCHITECTURE Pty Ltd (PSA). It may not be used for any purpose without the express written authority of PSA. Any unauthorised changes made to this design constitutes an infringement of Copyright.

SCALE AT A1:: SCALE AT A3:: REFER ABOVE N/A DATE:

JOB REF: SEE NOTES A1305

DRAWN: ARCHITECT REG No: YY/CH/PS 2486 (2152)

C 12.12.13 DA AMENDMENT B 09.10.13 DA AMENDMENT A 04.09.13 ISSUE TO TPG

3 0 JAN 2014

REVISED

PLANS

STREET ELEVATION

DWG No. :

DRAWING:

SK3.5



REVISED **PLANS**

3 0 JAN 2014

PHILIP STEJSKAL ARCHITECTURE PTY LTD atf PR STEJSKAL Family Trust ABN 93 854 818 466

PHILIP STEJSKAL A R C H I T E C T U R E m: 0401 727 405 e: philip@architectureps.com.au David SHARP + Iris BARTEN 1/219 BROOME ST COTTESLOE WA 6011

© COPYRIGHT: This design + drawing remains the property of PHILIP STEJSKAL ARCHITECTURE Pty Ltd (PSA). It may not be used for any purpose without the express written authority of PSA. Any unauthorised changes made to this design constitutes an infringement of Copyright.

SCALE AT A1:: N/A DATE: SEE NOTES

DRAWN:

YY/CH/PS

SCALE AT A3:: REFER ABOVE

JOB REF: A1305

ARCHITECT REG No:

2486 (2152)


E 11.12.13 DA AMENDMENT A 04.09.13 ISSUE TO TPG

DRAWING:

E

STREET PERSPECTIVE

SK3.6

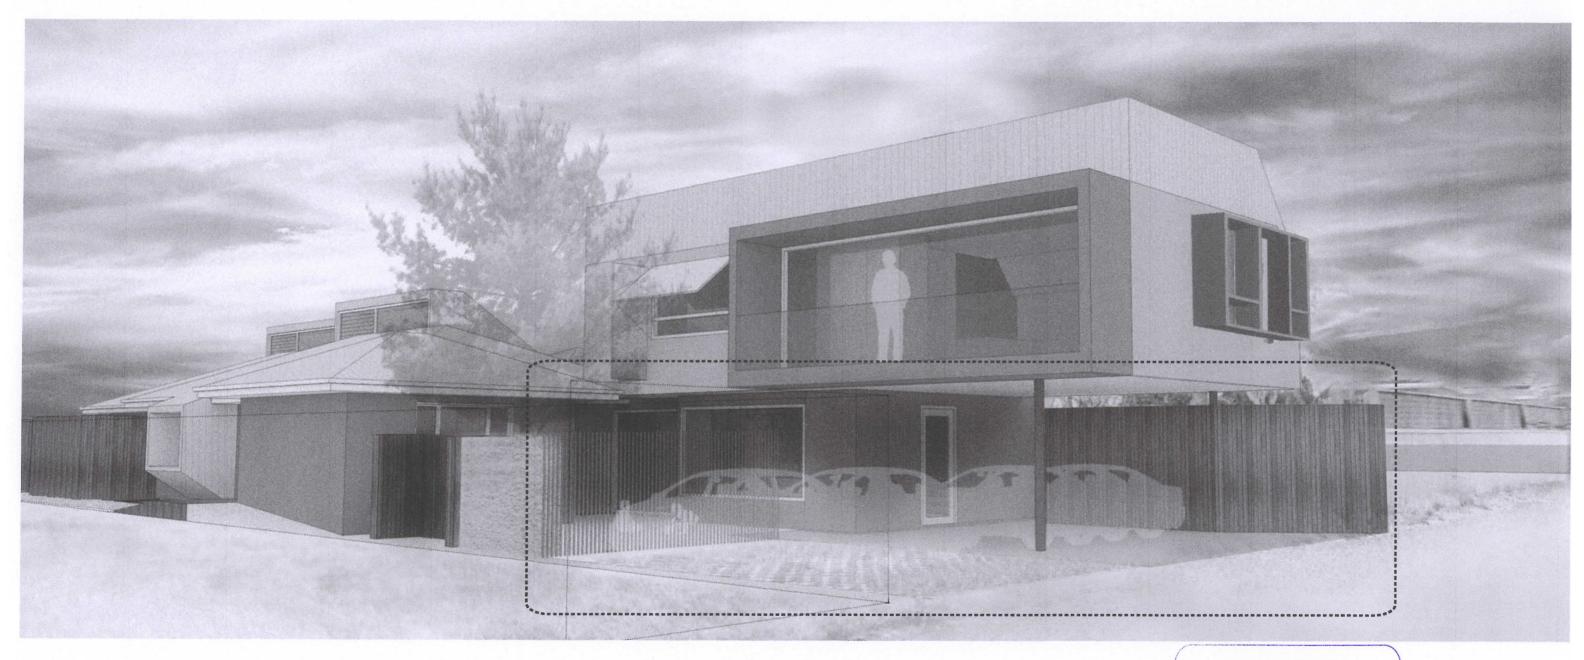

REVISED PLANS

TOWN OF COTTESLOE
3 0 JAN 2014
RECEIVED

سو اما دد ام و بدر دار داد ام

PHILIP STEJSKAL ARCHITECTURE PTY LTD atf PR STEJSKAL Family Trust
ABN 93 854 818 466

PHILIP STEJSKAL A R C H I T E C T U R E m: 0401 727 405 e: philip@architectureps.com.au David SHARP + Iris BARTEN
1/219 BROOME ST
COTTESLOE WA 6011

© COPYRIGHT: This design + drawing remains the property of PHILIP STEJSKALARCHITECTURE PtyLtd (PSA). It may not be used for any purpose without the express written authority of PSA. Any unauthorised changes made to this design constitutes an infringement of Copyright.

 SCALE AT A1::
 SCALE AT A3::

 N/A
 REFER ABOVE

 DATE:
 JOB REF:

 SEE NOTES
 A1305

 DRAWN:
 ARCHITECT REG No:

2486 (2152)

YY/CH/PS

F 20.01.14 DA AMENDMENT
E 11.12.13 DA AMENDMENT
C 28.11.13 DA AMENDMENT
B 09.10.13 DA AMENDMENT
A 12.09.13 PLANNING APPLICATION


RECEIVED


LANEWAY PERSPECTIVE


DWG No. :

DRAWING :

SK3.7

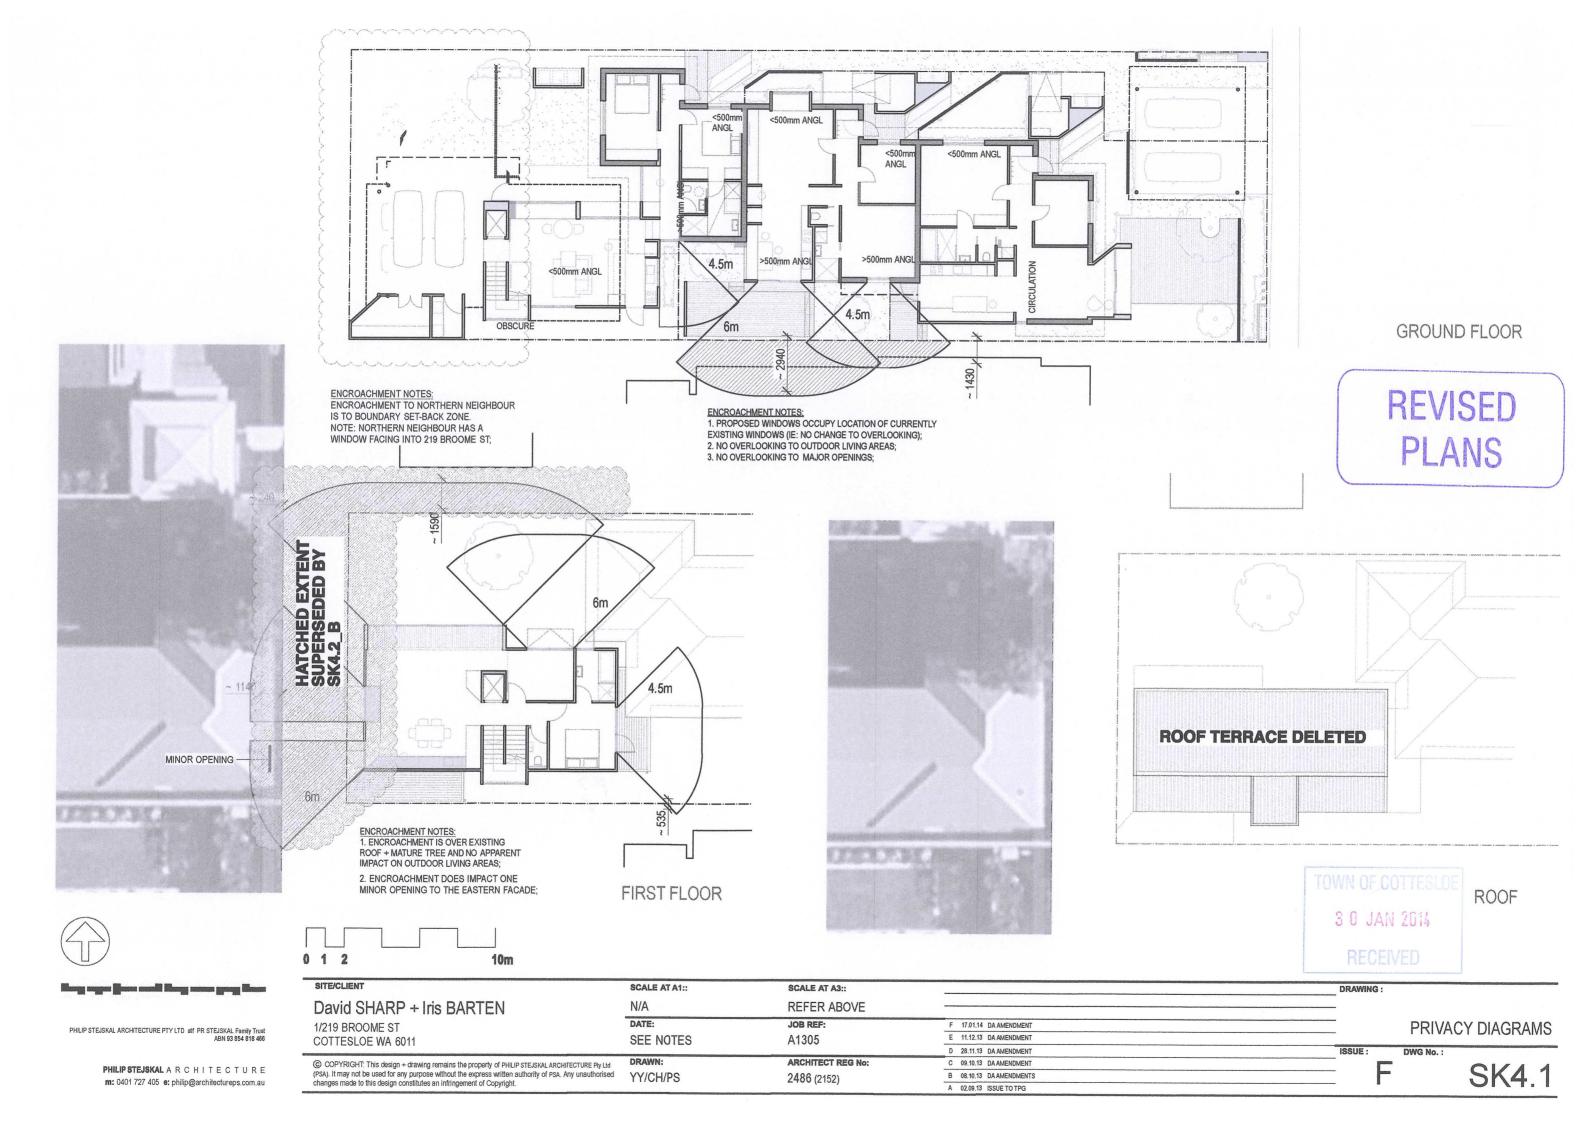

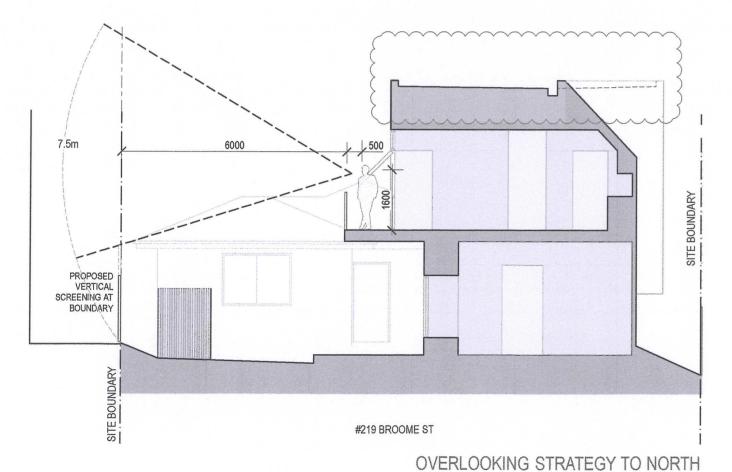

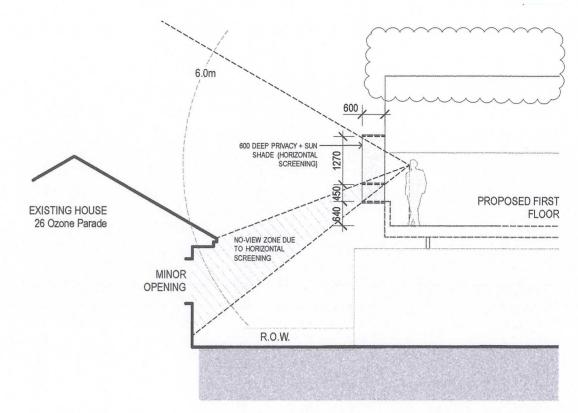

OVERLOOKING STRATEGY TO WEST

DRAWING:

REVISED **PLANS**

3 0 JAN 2014

0 .5 1 5m

PHILIP STEJSKAL ARCHITECTURE PTY LTD atf PR STEJSKAL Family Trust ABN 93 854 818 466

PHILIP STEJSKAL A R C H I T E C T U R E m: 0401 727 405 e: philip@architectureps.com.au David SHARP + Iris BARTEN

1/219 BROOME ST COTTESLOE WA 6011

© COPYRIGHT: This design + drawing remains the property of PHILIP STEJSKAL ARCHITECTURE Pty Ltd (PSA). It may not be used for any purpose without the express written authority of PSA. Any unauthorised changes made to this design constitutes an infringement of Copyright.

SCALE AT A1:: SCALE AT A3:: N/A REFER ABOVE DATE:

JOB REF: A1305 SEE NOTES ARCHITECT REG No:

DRAWN: YY/CH/PS 2486 (2152)


ISSUE : E 11.12.13 DA AMENDMENT C 09.12.13 DA AMENDMENT B 28.11.13 DA AMENDMENT A 04.09.13 ISSUE TO TPG

PRIVACY DIAGRAMS

SK4.2

3 0 JAN 2014


REVISED PLANS

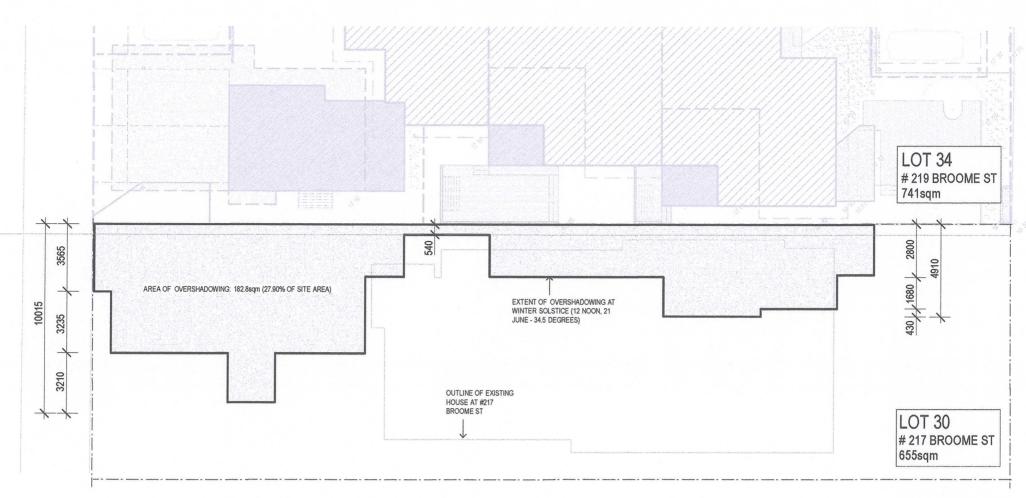

12 NOON WINTER SOLSTICE 21 JUNE; SUN ANGLE: 34.5 DEG

OVERSHADOWING PLAN

1:200

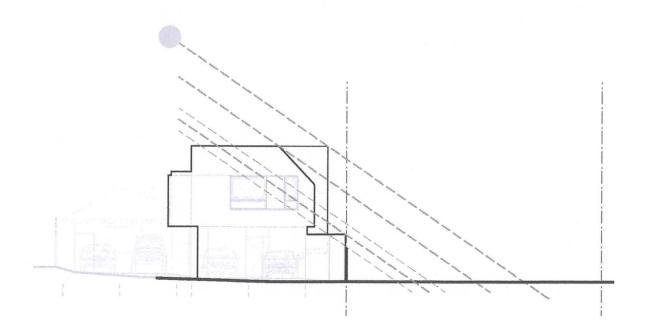



12 NOON WINTER SOLSTICE 21 JUNE; SUN ANGLE: 34.5 DEG
OVERSHADOWING SECTIONS
1:200

DRAWING:

PHILIP STEJSKAL ARCHITECTURE PTY LTD aff PR STEJSKAL Family Trust ABN 93 854 818 466

> PHILIP STEJSKAL A R C H I T E C T U R E m: 0401 727 405 e: philip@architectureps.com.au

David SHARP + Iris BARTEN
1/219 BROOME ST
COTTESLOE WA 6011

© COPYRIGHT: This design + drawing remains the property of PHILIP STEJSKAL ARCHITECTURE Pty Ltd (PSA). It may not be used for any purpose without the express written authority of PSA. Any unauthorised changes made to this design constitutes an infringement of Copyright.

YY/CH/PS

JOB REF:
A1305

ARCHITECT REG No:
2486 (2152)

B 12.12.13 DAAMENDMENT

A 02.09.13 ISSUE TO TPG

OVERSHADOWING

DWG No. :

SK4.3

PREVIOUS REPORT FROM COUNCIL MINUTES - 16 DECEMBER 2013

1.1 REPORTS OF COMMITTEES

1.2 DEVELOPMENT SERVICES COMMITTEE MINUTES - 09 DECEMBER 2013

Cr Downes declared an impartiality interest in item10.3.1 No. 219 (Lot 34) Broome Street - Alterations and Additions to Three Units, due to having some conveyancing done by Mrs Carol Knowles of 217 Broome Street, and stated that as a consequence there may be a perception that her impartiality may be affected and declared that she would consider the matter on its merits and vote accordingly.

1.2.1 NO. 219 (LOT 34) BROOME STREET - ALTERATIONS AND ADDITIONS TO THREE UNITS

File Ref: Attachments: 2765

Aerial

Plans **Property Photos**

Responsible Officer:

Carl Askew

Chief Executive Officer

Author:

Ronald Boswell, Planning Officer

Andrew Jackson, Manager Development Services

Proposed Meeting Date:

09 December 2013

Author Disclosure of Interest: Nil

Property Owner:

David Sharp

Applicant: Date of Application: The Planning Group 17 September 2013

Zoning:

Residential R20

Lot Area: M.R.S. Reservation: 742m²

N/A

SUMMARY

This application is seeking the following variations to Council's Town Planning Scheme No. 2 (TPS 2) and Residential Design Codes (RDC):

- Building height.
- Setback to southern boundary.
- Visual privacy.
- Overshadow.

These aspects are discussed in this report and refer to a series of plans as received on 17 September, 15 October, 28 November and 2 December 2013.

While certain aspects of the proposal don't automatically comply with TPS 2 and the RDC, the proposal does comply with Council's Fencing Local Law and retains the existing dwellings.

Given the assessment that has been undertaken, the recommendation is to conditionally approve the application.

PROPOSAL

This development application is for alterations and additions to three older triplex units and entails:

Unit 1

Additions:

- Extension to the front.
- Enclose existing sleep-out.
- Decks to the front and rear; rear screened.
- Front carport.
- External storage space/bin space.
- Semi-permeable front fencing and screen fence to carport.
- Light scoop/highlight window to top of roof.

Alterations:

Internal fit-out/layout.

Unit 2

Additions:

- Enclose existing sleep-out.
- Deck to the rear of unit, screened.
- Front carport.
- External storage space/bin space.
- Light scoop/highlight window to top of roof.
- Extension to living room to include daybed.

Alterations:

Internal fit-out/layout.

Unit 3

Additions:

- Extension to the rear including carport, second store with balcony and roof terrace.
- Store/workshop to rear.
- External storage space/bin space.

Alterations:

Internal fit-out/layout.

Buildings to be demolished

- External laundry.
- Shed to the rear.

BACKGROUND

Following discussions with the Town, the applicant has submitted revised plans addressing the design and appearance of the proposed improvements to the units, to better satisfy TPS 2 and the RDC. These are relatively minor though beneficial changes, whereby a number of concessions are still sought.

The Town's records do not indicate planning approval for the existing three units built sometime in the 1950s which, density-wise, exceed today's R20 standard. Although the units are a given and upgrading of dwellings is desirable, the proposal would reinforce this anomaly. Nonetheless, retaining established housing stock and enhancing streetscapes by transforming older dwellings are broad planning objectives.

Initially, the current owner applied to the WAPC for the units to be survey-strata subdivided, but has deferred that application pending this development proposal. The Town's position is that it is difficult to support such a survey strata subdivision in this predominantly low density single residential area of lots greater than 600m² with 15m frontages.

To elaborate, the lot is $742m^2$ and Residential R20 under TPS 2. The RDC require new survey strata lots to be a minimum of $350m^2$ and average of $450m^2$. The intended survey strata lots would fall far short of these sizes and be inconsistent with the density coding and single residential character of the area (ie U1 – $234m^2$; U2 – $165m^2$; U3 – $289m^2$; common property – $54m^2$).

Also, they would not satisfy the RDC criteria for a marginal reduction in minimum and average site areas for existing grouped dwellings. On this basis, further development of such survey strata lots would be contrary to TPS2, the objectives of the RDC and the orderly and proper planning of the locality.

Putting aside the question of a possible survey-strata subdivision, this development application in itself can be considered due to the existing use right for the three dwellings, in assessing the usual parameters under TPS 2 and the RDC.

In this regard the existing triplex building is of relatively modest footprint and scale, consistent with the single storey height regime of TPS 2, whereby ground floor extensions and a partial second storey would be essentially compatible with the streetscape context of larger dwellings and the trend towards two-storeys – subject to the degree of compliance with planning requirements and the effects of the design, as assessed below.

FINANCIAL IMPLICATIONS

Nil.

STATUTORY ENVIRONMENT

TPS 2

- RDC
- Fencing Local Law

PROPOSED LOCAL PLANNING SCHEME NO. 3

No change is proposed to the zoning or density of this lot.

HERITAGE LISTING

N/A.

Application Assessment

Areas of non-compliance:

TPS 2

Building Height	Permitted	Proposed
	Single storey:	Unit 1 – 6.35m – light
	Max. height: 6m.	scoop.
		Unit 2 – 6.45m – light
		scoop.
	<u>Two storey:</u>	Unit 3 – 8.45m – lift and
	Max. wall / flat roof height – 7m.	stairwell.

RDC

Design Element	Deemed-to- comply	Proposed	Design Principles
5.1.3 Lot boundary setback.	1.5m	1m – unit 1 southern wall.	Clause P3.1 Buildings set back from lot boundaries.
	1.2m	1m – unit 3 wall to stairwell.	
	3.5m	2.5m – unit 3 roof terrace.	
5.4.1 Visual privacy.	4.5m	3.96m – master bedroom eastern window.	P1.2 Maximum visual privacy to side and rear
	6m	4.86m – upper floor western window.	boundaries.
	7.5m	7.25m, 5.04m – roof terrace northern and western elevations.	
		5.91m – balcony, northern elevation.	

	25% overshadow.	28% overshadow.	P2.1 Effective solar access for the proposed development and protection of solar access.
TPS2 Policy 3 front carports.	6m	1.2m	Clause 4 (b).

ADVERTISING OF PROPOSAL

The application was advertised in accordance with TPS 2 by letter to five adjoining property owners. Three submissions were received, from the northern, eastern and southern neighbours. The main comments received are summarised below:

T & C Knowles, 217 Broome Street

- Strongly objects to any overshadow concession from the proposed addition to the rear unit. The development should comply with the 25% overshadow allowance.
- Objects to the bulk and scale of the rear addition as it will be an eyesore affecting the enjoyment of our backyard.
- Objects to the roof terrace, including that it may become enclosed or a roofed structure could be sought in the near future if approved.
- Objects to increasing the size of the units as they are already over-dense on a lot that should support only a single residence at R20 – disagrees with allowing a non-conforming development to become larger.
- The three units have an already increased vehicle impact on neighbour amenity. Parking on the lot would be more favourable than using the verge.
- Objects to the units becoming survey strata or green title.
- Concerned that the carport at the rear may become enclosed.
- Objects to concession for the units to be over-height.
- There is insufficient land to support two car parking bays for the two front units, therefore the owner/applicant is seeking a concession from Council for two car parking bays to be located on the verge. Therefore this clearly demonstrates that there is insufficient land for the proposed development.
- Objects to vehicles driving over the 217 Broome Street verge to park on the 219 Broome Street verge.

P & K Law, 26 Ozone Parade

- Strongly objects to the roof terrace to rear unit.
- Objects to the rear unit being over-height.
- Concerns with use of the roof terrace as a habitable area as indicated on the plans with a table, chairs and shower.

- Objects to any overlooking onto their property that does not meet the RDC requirements.
- Requests that the rear unit be built within the compliant building envelope for height and setbacks as defined in the RDC.

G & B Leclezio, 221 Broome Street

- Strongly objects to the triplex increasing in size beyond the density of other houses in the street – no concessions should be given to this non-conforming dwelling.
- Objects to the roof terrace and balcony overlooking their private courtyard and outdoor living areas.
- Objects to the extension to the rear unit, as overlooking will occur into their lounge room, kitchen, master bedroom and ensuite.

APPLICANT'S JUSTIFICATION

A summary of the applicant's comments regarding the revised plans is as follows:

Roof terrace and lift shaft access

- The lift shaft access is located in the centre of the site, it is not considered to have any adverse impact on the adjoining properties or the streetscape in terms of bulk and scale and will be considerably less imposing than the adjoining twostorey dwelling.
- Horizontal screening to the south has been provided, and only marginally encroaches upon the northern property. This will be addressed by providing screening on the boundary.
- Encroachment to the west is more significant, but doesn't seem to impact on outdoor habitable areas. However, this will be addressed by installing privacy screens to the west.
- The roof terrace does not look over any habitable areas of No. 26 Ozone Parade.

Overlooking

- Balcony:
 - Addressed by screening on the northern boundary.
 - The cone of vision does not encroach upon any habitable spaces at No. 221 Broome Street, as it faces a blank wall.
- Windows to the first floor on the western elevation:
 - Fixed privacy fins that extend from the edge of the opening to direct sightlines away from the openings /outdoor living areas of neighbours are proposed.

Overshadow

• Is not considered to have an adverse impact on the adjoining property. The adjoining property to the south has large trees on the boundary which already cast a shadow over the back yard of No. 217 Broome Street.

Bulk and scale

 Bulk and scale has been reduced from the streetscape as the two-storey competent is located to the rear of the lot.

Building height of units one and two

 There is no overshadowing or visual privacy issue due to the angle of the skylights, nor is height an issue of bulk and scale as they are set back considerably.

Unit one verge parking bays

• This will form a separate application to the Engineering Department for approval.

Pedestrian access (common property for units if a survey strata)

- Residents from unit one arriving by car can access directly through the unit one carport and residents arriving on foot go around the unit two carport to the north, not through it.
- Any shared property would be dealt with by implementing cross-easements in favor of each unit.
- A survey strata application can show amendments to allow adequate maneuverability between objects such as meter box/mailboxes.

Concerns regarding additional vehicle movements

• The proposal formalises parking on the lot as at present no on-site parking is available and vehicles use the verge.

Unit one setback

• The southern wall requires a 1.5m setback, while 1m is proposed. This is an extension of an existing wall and is not considered to have any adverse impact on the adjoining neighbour.

Unit three setback

• The southern elevation stairwell requires 1.2m, while 1m is proposed. This could be treated as a minor architectural projection and can be reduced in depth by 200mm to comply.

Rear on-site vehicle turning circle

 Adequate manoeuvrability from the carport of unit three to the ROW has been achieved and is supported by the Manager Engineering services.

OFFICER'S COMMENT

The following technical assessment is made regarding this development application:

Site cover

It is noted that despite the additions made to each unit the site cover has not been compromised, as 50% open space is available for the lot in total and for each unit, calculated on the site area provided.

Boundary Setbacks

The proposal involves setback variations for the southern and western elevations. They are assessed as satisfying the RDC design principles.

For unit one, the front addition has created a continuation of the southern wall. The required setback is 1.5m from the southern boundary and 1m is proposed. This extension is modest and the setback would not affect the neighbouring property.

For unit three, the rear addition stairwell on the south has a setback requirement of 1.2m and 1m is proposed. The 0.2m reduction is minor and the window is to be obscure-glazed. This could be allowed or designed to comply – a condition for the latter is recommended.

For the upper level western wall, a 3.5m setback is required and 1m is proposed from the boundary; however, under the RDC half the width (1.5m) of the lane can be claimed, hence the setback equates to 2.5m or a 1m reduction. In terms of built form, due to the physical separation of the lane this may be supported as the bulk and scale of the building is ameliorated compared with buildings separated by a shared boundary.

Building Height

The calculation of building height stems from the determination of the natural ground level (NGL). Under TPS 2 variations may be permitted in the case of extensions to existing buildings, subject to satisfactory amenity. For this proposal the NGL has been determined from the location of each unit as derived from the site survey plan (being U1 – RL: 17.2m; U2 – RL: 17.3m; U3 – RL: 17.4m).

Units one and two, to the front and middle of the lot, are over-height due to the addition of their light scoop/highlight window roof forms, which at their apex are 0.35m and 0.45m above the 6m height standard for a single-storey dwelling. These may be considered as an architectural feature under the design principles of the RDC, which state:

Building height that creates no adverse impact on the amenity of adjoining properties or the streetscape, including road reserves and public open space reserves; and where appropriate maintains:

- Adequate access to direct sun into buildings and appurtenant open spaces;
- Adequate daylight to major openings into habitable rooms; and
- Access to views of significance.

However, whilst the purpose of the light scoops/highlight windows can be supported, their form appears discordant and adds to the mass of the overall roof-scape. To address this, their redesign to follow the existing roof pitch and not exceed the height standard is conditioned accordingly in the recommendation.

Unit 3 at the rear is a flat roof design which complies with the 7m height standard of the RDC, including the roof terrace element except for the lift shaft/stairwell extension. This element is a fairly substantial wall/roof form taking the height another 1.45m to 8.45m. This is just under the 8.5m roof height standard for a two-storey pitched-roof design, albeit not directly comparable.

On the one hand this element could be allowed as a projection which occupies a relatively small area albeit as a relatively large height variation. On the other hand the degree of height variation could be considered excessive and the form of the element as too bulky or even awkward. One way of addressing this would be to condition an approval to maybe delete or at least substantially modify the lift shaft/stairwell projection and possibly rely on a stairwell with access hatch instead. This would achieve height compliance and reduce overshadow whist allowing the roof terrace, though perhaps functioning less conveniently.

Roof terraces are becoming quite popular, for innovative use of space and the enjoyment of the climate and views. They can, however, be contentious in relation to building height/bulk, overlooking, overshadowing and amenity. The RDC recognise roof terraces as open space and subject to privacy controls. The Town has experience with roof terrace proposals. Those at the front of dwellings looking to the street tend to be acceptable, while those to the side or rear of dwellings tend to be more problematic.

The proposed roof terrace is a nice idea for the lifestyle of the rear unit. It is in addition to the ground floor private open space and upper floor balcony, and is not needed in order to provide the minimum required amount of private open space. The terrace balustrade is formed by the walls of the two-storey addition, within the 7m height measure. If the height of the lift shaft/stairwell is resolved, consideration of the roof terrace remains a privacy matter, as discussed below.

Visual Privacy

Technically privacy aspects do not arise for the single-storey units one and two, due to a compliant design and supplementary screening.

The introduction of a rear second storey and roof terrace give rise to privacy considerations. The setbacks to windows, the balcony and roof terrace are less than the RDC deemed-to comply-standards, whereby the cones of vision affect adjacent properties and this is of concern to neighbours.

The western window overlooks mainly the rear lane and the cone of vision falls to the roof or the dwelling opposite, which has an obscure-glazed window. The applicant has

provided widow box type screens to this window to reduce the field of view. This privacy interrelationship is considered acceptable.

The northern balcony is setback 6m in lieu of 7.5m, with full height solid screening to its eastern and western ends, which restricts the cone of vision. The privacy intrusion extends into the northern property, falling between the boundary fence and a two-storey rear outbuilding (ground floor garage and upper floor ancillary accommodation, which has one window looking towards the subject property. This privacy interrelationship can be considered reasonable, as the balcony is not deep and the interface between the neighbouring buildings is fairly discrete. This arrangement of locating habitable rooms on the southern side of a lot, with openings gaining northern exposure, and overlooking private open space before reaching a northern adjacent property, is a sound design approach.

The roof terrace is setback 7.25m from the northern boundary, just shy of the 7.5m deemed-to-comply standard. This could be accepted as a minor variation or conditioned for a minor design change to comply. To the east the roof terrace overlooks the subject property falling mainly to the roof-scape, which is of little consequence. To the south the roof terrace overlooks the neighbouring back yard but more as a "view over" due to the line of sight being setback, yet the sense of privacy being affected may prevail. To west the outlook is upon the lane and roof of the dwelling opposite, again for a somewhat "distant" view which may also create a sense of privacy intrusion.

Deletion of the roof terrace altogether would obviously remove this privacy situation. Alternatively, the design could be modified to limit the size of the roof terrace, increasing its setbacks or adding screening devices. For example, extending the horizontal plane of the southern edge of the roof terrace would deflect the overlooking above the adjacent property. To the west a greater setback, such as in the form of a fixed/built-in planter box would achieve a similar positive outcome. A condition is recommended accordingly.

Overshadow

The second storey with roof terrace rear addition creates 28% overshadow to the southern property, which is marginally in excess of the RDC standard of 25%. Two-storey proposals on east-west orientated lots typically cause overshadowing, often exceeding the standard, which design may address to some extent.

This extra overshadow could, however, be allowed under the design principles of the RDC. Lowering and reconfiguration of the lift shaft/stairwell as recommended should reduce overshadow onto the southern property.

Vehicle parking

At present there is no on-site parking and occupants park on the verge, which is unsightly and has caused neighbour concern. The proposal addresses this in providing four parking bays on the lot. The parking arrangement comprises:

- Open-aspect single carports in the front setback for units one and two, setback 1.2m.
- An open-aspect double carport at the rear off the ROW for unit three.
- One additional parking bay each for units one and two formalised on the verge.

This is supported to satisfy the RDC requirement of two parking bays per dwelling. The verge bays will require detailed design to satisfy the Town's engineering/works requirements, including protection of the street tree. Council can support the front carport under its planning policy for such, as approved next door at 217 Broome Street.

CONCLUSION

The thrust of the proposal to upgrade the traditional triplex can be supported inprinciple. Although the number of dwellings is over-density, the footprint and massing of the additions and alterations as one overall built form reflects modern large single dwellings in the locality and the emergent two-storey norm.

The proposal is technically compliant in many respects and several of the variations sought can be supported where they have little effect.

Building height complies for the predominant portion of the overall development, with the variations sought being due to novel design elements, which while intelligent solutions in themselves do generate valid concerns and could be addressed by design modifications.

In conclusion, the basic intent to upgrade the dwellings and the design concept is supported, conditional upon certain revisions to address the aspects identified in order to deliver appropriate aesthetics and amenity.

COMMITTEE COMMENT

Committee discussed the matter at length having regard to the officer report, presentations and neighbour concerns. Committee considered that the existing overdensity, non-conforming triplex and the significant concessions sought indicated that the proposal was excessive and should not be supported. Issues included the height, setbacks, privacy (including roof terrace), overshadow and parking; whereby the development would be overpowering and amount to a medium density contrary to the existing R20 character and amenity expectations of residents.

The Manager Development Services confirmed that under the TPS2 R20 zoning three new dwellings could not be approved. He went on to advise that given Committee was not inclined to support the proposal the options were deferral for redesign or refusal with reasons. Noting that the revised plans tabled had not been assessed he advocated

deferral to allow discussion with the applicant towards further advice to Council, either at the 16 December 2013 meeting or the 24 February 2014 meeting – adding that a significantly modified design that is largely compliant might be able to be considered under Special Delegation during the holiday recess, although if still contentious it would be referred to the February Council meeting.

VOTING

Simple Majority

OFFICER RECOMMENDATION

Moved Cr Birnbrauer,	seconded
----------------------	----------

THAT Council GRANT conditional approval to commence development for alterations and additions to three units, including second storey and roof terrace to rear unit, carports, decks, storage/bin spaces and front fencing, at 219 (Lot 34) Broome Street, Cottesloe, in accordance with the plans received on 17 September 2013, 15 October 2013, 28 November 2013 and 2 December 2013, subject to the following conditions:

- (1) At building permit stage, revised plans shall be submitted for approval to the satisfaction of the Manager Development Services addressing the following:
 - a. the lift shaft and stairwell element shall be redesigned to: substantially reduce its excess height above 7m; substantially reduce its bulk and scale; and be setback a minimum of 1.2m from the southern boundary;
 - b. the roof terrace shall be redesigned to: achieve a 7.5m setback from the northern boundary; substantially reduce overlooking towards the southern property (such as by an increased setback or increased horizontal screening; and substantially reduce overlooking towards the western property across the lane (such as by an increased setback, horizontal screening or an in-built/fixed planter box); and
 - c. the light scoops/highlight window roof forms shall be reduced in height to not exceed 6m and modified to follow the existing roof pitch.
- (2) All construction work being carried out in accordance with the Environmental Protection (Noise) Regulations 1997, Regulation 13 Construction Sites.
- (3) The external profile of the development as shown on the approved plans not being changed, whether by the addition of any service plant, fitting, fixture or otherwise, except with the written consent of Council.
- (4) Air-conditioning plant and equipment shall be located closer to the dwelling than adjoining dwellings, and suitably housed or treated as may be necessary, to ensure that sound levels do not exceed those specified in the Environment Protection (Noise) Regulations 1997.

- (5) Where climatic and soil conditions allow for the effective retention of stormwater on-site, all water draining from roofs and other impermeable surfaces shall be directed to garden areas, sumps or rainwater tanks within the development site.
- (6) The roof surface being treated to reduce glare if Council considers that the glare adversely affects the amenity of adjoining or nearby neighbours following completion of the development.
- (7) The finish and colour of the boundary walls facing the southern neighbour and the ROW shall be to the satisfaction of the Manager Development Services.
- (8) All fencing in the 6 metre front setback area of the site shall be of open-aspect design in accordance with the Town's *Fencing Local Law*, with compliance to be clearly shown on the drawings submitted at building permit stage.
- (9) Existing street trees shall be retained and protected during building works by barriers around the bases of the trees, to the satisfaction of the Town's Works Supervisor.
- (10) A separate application for a new or reconstructed crossover meeting the Town's specifications shall be submitted for approval by the Manager Engineering Services or an authorised officer. The precise location and width of the crossover shall protect the street tree, to the satisfaction of the Town.
- (11) A separate application for two car parking bays in the verge meeting the Town's specifications shall be submitted for approval by the Manager Engineering Services or an authorised officer, and shall ensure the retention and protection of existing street trees.
- (12) Prior to the issue of a building permit, the landowner shall make a cash contribution to the Town towards the upgrade of the adjoining right-of-way, equivalent to 50% of the cost of constructing a portion of standard right-of-way for an area of 4m wide by 20m, as determined by the Manager Engineering Services.

Advice Notes:

- (1) The owner/applicant is responsible for ensuring that all lot boundaries shown on the approved plans are correct and that the proposed development is constructed entirely with the subject property.
- (2) The owner/applicant is responsible to apply to the Town for a Building Permit and to obtain approval prior to undertaking construction of the development. Proper and accurate scaled, dimensioned and annotated construction plans are required for that purpose.

(3) The owner/applicant is advised that this development approval shall not be construed as any indication that the Town may support a subsequent survey strata subdivision application for the property. The Town and the Western Australian Planning Commission may not be able to support such an application, irrespective of this development approval.

The motion lapsed for want of a seconder

NEW MOTION AND COMMITTEE RECOMMENDATION

That the item be deferred for further liaison between the applicant and the Town, with a view to further revised plans and another report to Council for determination of the proposal.

COUNCIL DISCUSSION

Prior to considering the Committee Recommendation, Council discussed the memo from Manager of Development Services which contained a set of 'alternative recommendations'. Council then discussed these alternatives.

ALTERNATIVE MOTION

Moved Cr Jeanes, seconded Cr Birnbrauer

THAT Council GRANT approval to commence development for alterations and additions to three existing units at 219 (Lot 34) Broome Street, Cottesloe, in accordance with the further revised set of plans received on 12 December 2013, subject to the following conditions:

- (1) At building permit stage, revised plans shall be submitted for approval to the satisfaction of the Manager Development Services addressing the following:
 - a. the light scoop/highlight window roof forms shall be reduced in height to not exceed 6m from natural ground level as determined by the Town and be modified to follow the existing roof pitch:
 - b. the lift shaft and stairwell shall be setback a minimum of 1.2m from the southern boundary;
 - c. deletion of the proposed two dedicated parking bays on the proposed crossover;
 - d. the rear carport with lane access shall be redesigned to accommodate four cars by way of angle parking, to the satisfaction of the Town; and
 - e. the levels of the three terraces along the southern side of the lot shall be as low as reasonably possible and their privacy screens shall be of sufficient height, having regard to ground levels, fence heights and vegetation in relation to the southern adjacent property.

- (2) All construction work being carried out in accordance with the Environmental Protection (Noise) Regulations 1997, Regulation 13 Construction Sites.
- (3) The external profile of the development as shown on the approved plans not being changed, whether by the addition of any service plant, fitting, fixture or otherwise, except with the written consent of Council.
- (4) Air-conditioning plant and equipment shall be located closer to the dwelling than adjoining dwellings, and suitably housed or treated as may be necessary, to ensure that sound levels do not exceed those specified in the Environment Protection (Noise) Regulations 1997.
- (5) Where climatic and soil conditions allow for the effective retention of stormwater on-site, all water draining from roofs and other impermeable surfaces shall be directed to garden areas, sumps or rainwater tanks within the development site.
- (6) The roof surface being treated to reduce glare if Council considers that the glare adversely affects the amenity of adjoining or nearby neighbours following completion of the development.
- (7) The finish and colour of the boundary walls facing the southern neighbour and the ROW shall be to the satisfaction of the Manager Development Services.
- (8) All fencing in the 6 metre front setback area of the site shall be of openaspect design in accordance with the Town's *Fencing Local Law*, with compliance to be clearly shown on the drawings submitted at building permit stage.
- (9) Existing street trees shall be retained and protected during building works by barriers around the bases of the trees, to the satisfaction of the Town's Works Supervisor.
- (10) A separate application for a new or reconstructed crossover meeting the Town's specifications shall be submitted for approval by the Manager Engineering Services or an authorised officer. The precise location and width of the crossover shall protect the street tree, to the satisfaction of the Town.
- (11) A separate application for two car parking bays in the verge meeting the Town's specifications shall be submitted for approval by the Manager Engineering Services or an authorised officer, and shall ensure the retention and protection of existing street trees.

(12) Prior to the issue of a building permit, the landowner shall make a cash contribution to the Town towards the upgrade of the adjoining right-of-way, equivalent to 50% of the cost of constructing a portion of standard right-of-way for an area of 4m wide by 20m, as determined by the Manager Engineering Services.

Advice Notes:

- (1) The owner/applicant is responsible for ensuring that all lot boundaries shown on the approved plans are correct and that the proposed development is constructed entirely with the subject property.
- (2) The owner/applicant is responsible to apply to the Town for a Building Permit and to obtain approval prior to undertaking construction of the development. Proper and accurate scaled, dimensioned and annotated construction plans are required for that purpose.
- (3) The owner/applicant is advised that this development approval shall not be construed as any indication that the Town may support a subsequent survey strata subdivision application for the property. The Town and the Western Australian Planning Commission may not be able to support such an application, irrespective of this development approval.
- (4) The owner/applicant is advised that in granting this approval Council is not inclined to favourably consider any roof terrace addition to the property that may be proposed in the future.

AMENDMENT

Moved Mayor Dawkins, seconded Cr Birnbrauer

That the condition 11 of the alternative recommendation be deleted.

Carried 8/0

SUBSTANTIVE MOTION

THAT Council GRANT approval to commence development for alterations and additions to three existing units at 219 (Lot 34) Broome Street, Cottesloe, in accordance with the further revised set of plans received on 12 December 2013, subject to the following conditions:

(1) At building permit stage, revised plans shall be submitted for approval to the satisfaction of the Manager Development Services addressing the following:

- a. the light scoop/highlight window roof forms shall be reduced in height to not exceed 6m from natural ground level as determined by the Town and be modified to follow the existing roof pitch;
- b. the lift shaft and stairwell shall be setback a minimum of 1.2m from the southern boundary:
- c. deletion of the proposed two dedicated parking bays on the proposed crossover;
- d. the rear carport with lane access shall be redesigned to accommodate four cars by way of angle parking, to the satisfaction of the Town: and
- e. the levels of the three terraces along the southern side of the lot shall be as low as reasonably possible and their privacy screens shall be of sufficient height, having regard to ground levels, fence heights and vegetation in relation to the southern adjacent property.
- (2) All construction work being carried out in accordance with the Environmental Protection (Noise) Regulations 1997, Regulation 13 Construction Sites.
- (3) The external profile of the development as shown on the approved plans not being changed, whether by the addition of any service plant, fitting, fixture or otherwise, except with the written consent of Council.
- (4) Air-conditioning plant and equipment shall be located closer to the dwelling than adjoining dwellings, and suitably housed or treated as may be necessary, to ensure that sound levels do not exceed those specified in the Environment Protection (Noise) Regulations 1997.
- (5) Where climatic and soil conditions allow for the effective retention of stormwater on-site, all water draining from roofs and other impermeable surfaces shall be directed to garden areas, sumps or rainwater tanks within the development site.
- (6) The roof surface being treated to reduce glare if Council considers that the glare adversely affects the amenity of adjoining or nearby neighbours following completion of the development.
- (7) The finish and colour of the boundary walls facing the southern neighbour and the ROW shall be to the satisfaction of the Manager Development Services.
- (8) All fencing in the 6 metre front setback area of the site shall be of openaspect design in accordance with the Town's *Fencing Local Law*, with compliance to be clearly shown on the drawings submitted at building permit stage.

- (9) Existing street trees shall be retained and protected during building works by barriers around the bases of the trees, to the satisfaction of the Town's Works Supervisor.
- (10) A separate application for a new or reconstructed crossover meeting the Town's specifications shall be submitted for approval by the Manager Engineering Services or an authorised officer. The precise location and width of the crossover shall protect the street tree, to the satisfaction of the Town.
- (11) Prior to the issue of a building permit, the landowner shall make a cash contribution to the Town towards the upgrade of the adjoining right-of-way, equivalent to 50% of the cost of constructing a portion of standard right-of-way for an area of 4m wide by 20m, as determined by the Manager Engineering Services.

Advice Notes:

- (1) The owner/applicant is responsible for ensuring that all lot boundaries shown on the approved plans are correct and that the proposed development is constructed entirely with the subject property.
- (2) The owner/applicant is responsible to apply to the Town for a Building Permit and to obtain approval prior to undertaking construction of the development. Proper and accurate scaled, dimensioned and annotated construction plans are required for that purpose.
- (3) The owner/applicant is advised that this development approval shall not be construed as any indication that the Town may support a subsequent survey strata subdivision application for the property. The Town and the Western Australian Planning Commission may not be able to support such an application, irrespective of this development approval.
- (4) The owner/applicant is advised that in granting this approval Council is not inclined to favourably consider any roof terrace addition to the property that may be proposed in the future.


Lost 1/7


COMMITTEE RECOMMENDATION & COUNCIL RESOLUTION

That the item be deferred for further liaison between the applicant and the Town, with a view to further revised plans and another report to Council for determination of the proposal.

THE MOTION WAS PUT

Carried 7/1

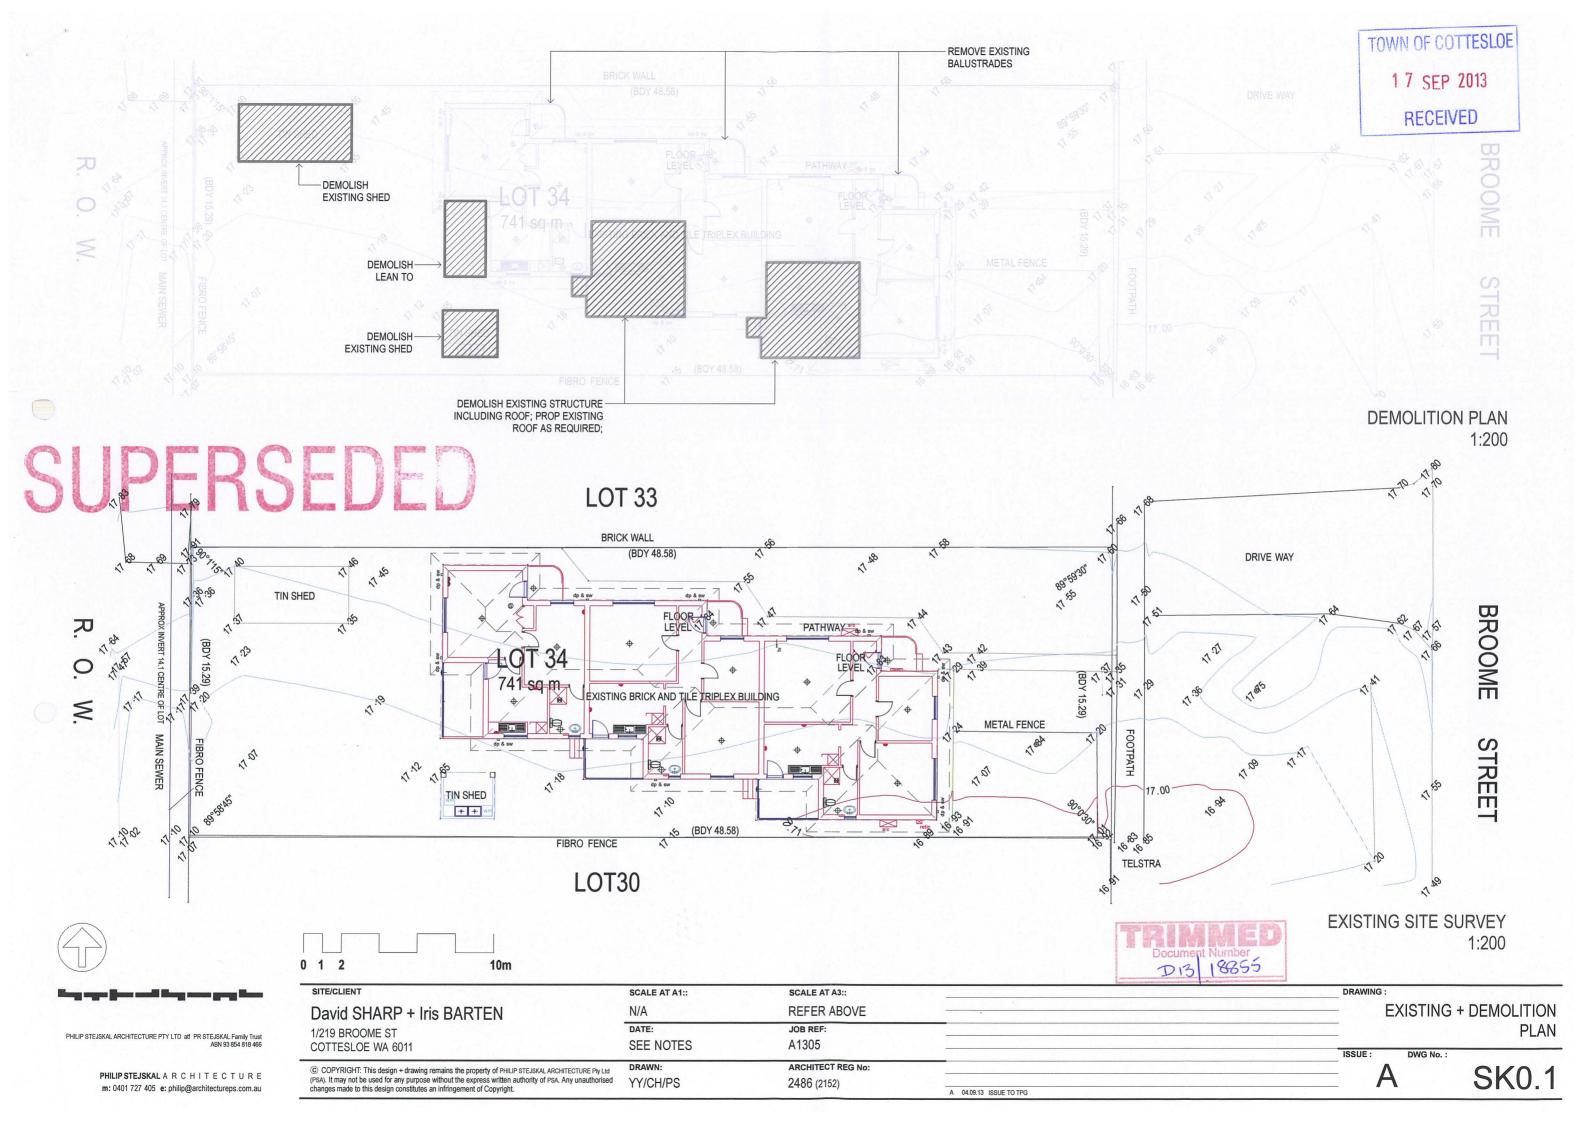

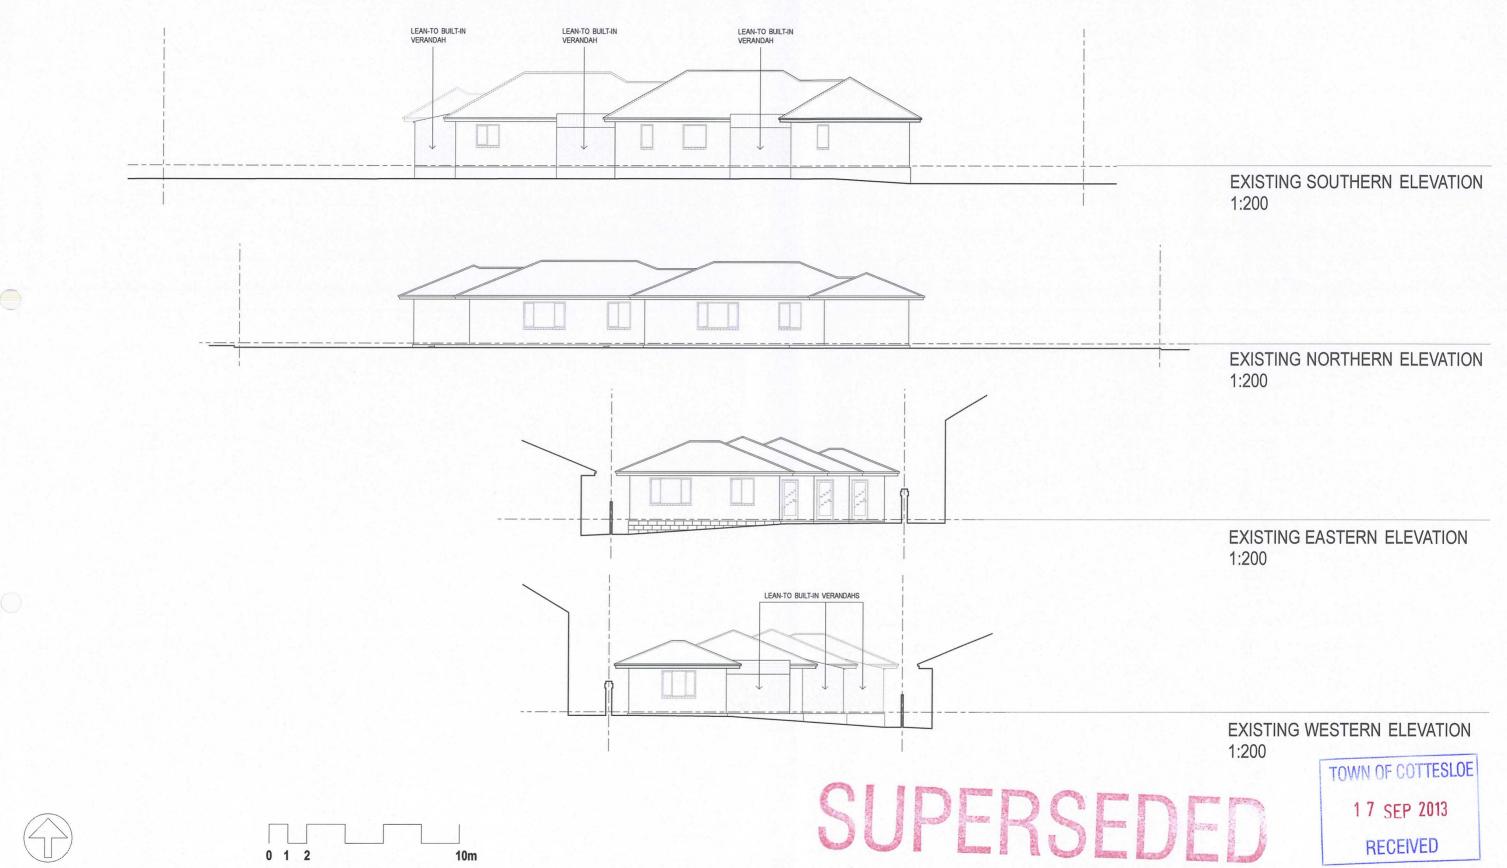

PHILIP STEJSKAL ARCHITECTURE PTY LTD atf PR STEJSKAL Family Trust ABN 93 854 818 466

PHILIP STEJSKAL A R C H I T E C T U R E m: 0401 727 405 e: philip@architectureps.com.au

SITE/CLIENT David SHARP + Iris BARTEN

1/219 BROOME ST COTTESLOE WA 6011

© COPYRIGHT: This design + drawing remains the property of PHILIP STEJSKAL ARCHITECTURE Pty Ltd (PSA). It may not be used for any purpose without the express written authority of PSA. Any unauthorised changes made to this design constitutes an infringement of Copyright.

SCALE AT A1:: SCALE AT A3:: N/A REFER ABOVE

DATE: JOB REF: SEE NOTES A1305


YY/CH/PS

ARCHITECT REG No: 2486 (2152) A XX.09.13 ISSUE TO TPG

EXISTING SITE ELEVATIONS

ISSUE: DWG No. :

SK0.2

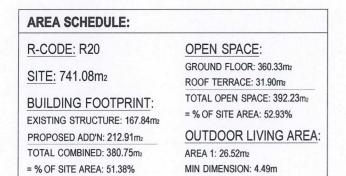


COTTESLOE WA 6011

PHILIP STEJSKAL A R C H I T E C T U R E

m: 0401 727 405 e: philip@architectureps.com.au

© COPYRIGHT: This design + drawing remains the property of PHILIP STEJSKAL ARCHITECTURE Pty Ltd

(PSA). It may not be used for any purpose without the express written authority of PSA. Any unauthorised changes made to this design constitutes an infringement of Copyright.

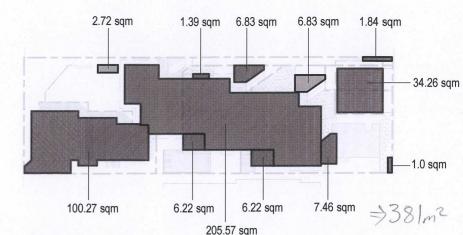


ISSUE:

B

DWG No. :

SK1.0

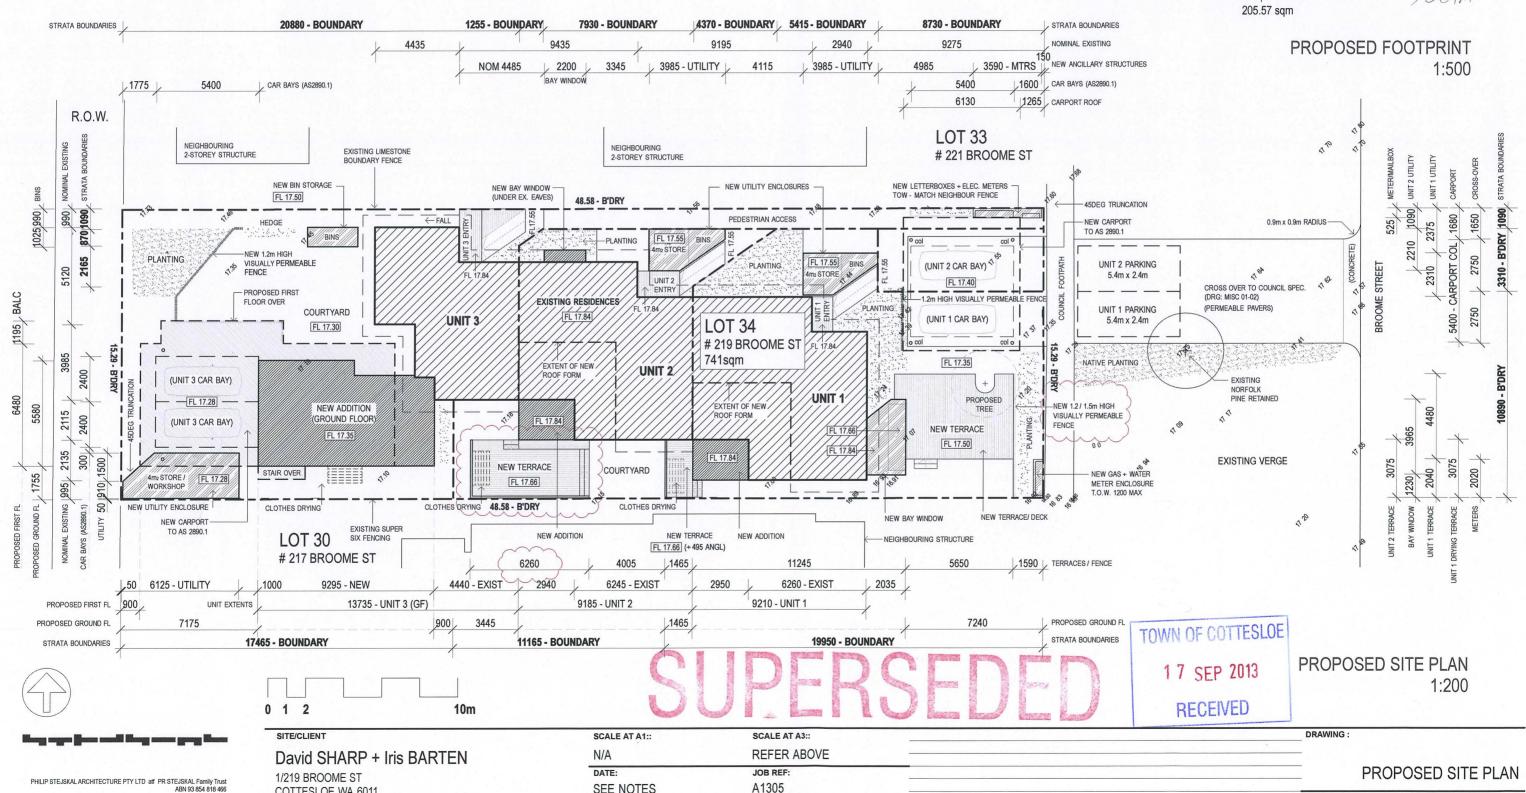

A1305

2486 (2152)

ARCHITECT REG No:

B 04.09.13 RF-ISSUE TO TPG

A 02.09.13 ISSUE TO TPG

SEE NOTES

YY/CH/PS

DRAWN:

AREA SCHEDULE: R-CODE: R20 **OPEN SPACE:** GROUND FLOOR: 360.33m2 SITE: 741.08m₂ ROOF TERRACE: 31.90m2 TOTAL OPEN SPACE: 392,23m2 **BUILDING FOOTPRINT:** = % OF SITE AREA: 52.93% EXISTING STRUCTURE: 167.84m2 **OUTDOOR LIVING AREA**: PROPOSED ADD'N: 212.91m2 TOTAL COMBINED: 380.75m2 AREA 1: 26.52m; = % OF SITE AREA: 51.38% MIN DIMENSION: 4.49m

COTTESLOE WA 6011

PHILIP STEJSKAL A R C H I T E C T U R E

m: 0401 727 405 e: philip@architectureps.com.au

© COPYRIGHT: This design + drawing remains the property of PHILIP STEJSKAL ARCHITECTURE Pty Ltd (PSA). It may not be used for any purpose without the express written authority of PSA. Any unauthorised


changes made to this design constitutes an infringement of Copyright.

TOWN OF COTTESLOE 2.72 sam 1.39 sqm 6.83 sqm 6.83 sqm 1.84 sam 7 OCT 2013 RECEIVED 34.26 sam -1.0 sqm D13/20094 100.27 sqm 6.22 sqm 6.22 sqm 7.46 sqm 205.57 sqm

ISSUE :

DWG No. :

SK1.0

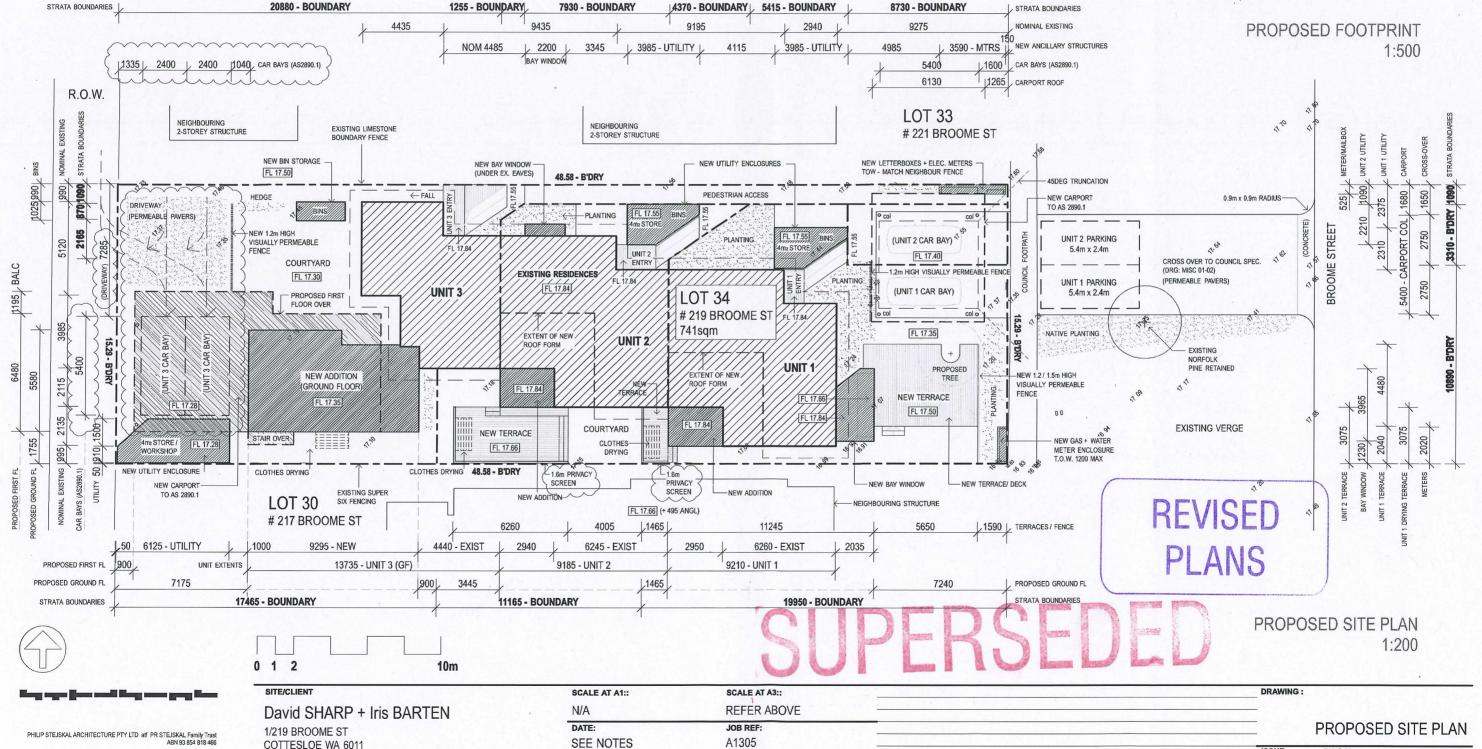

ARCHITECT REG No:


2486 (2152)


YY/CH/PS


C 03.10.13 DA AMENDMENTS


B 04.09.13 RE-ISSUE TO TPG


A 02.09.13 ISSUE TO TPG

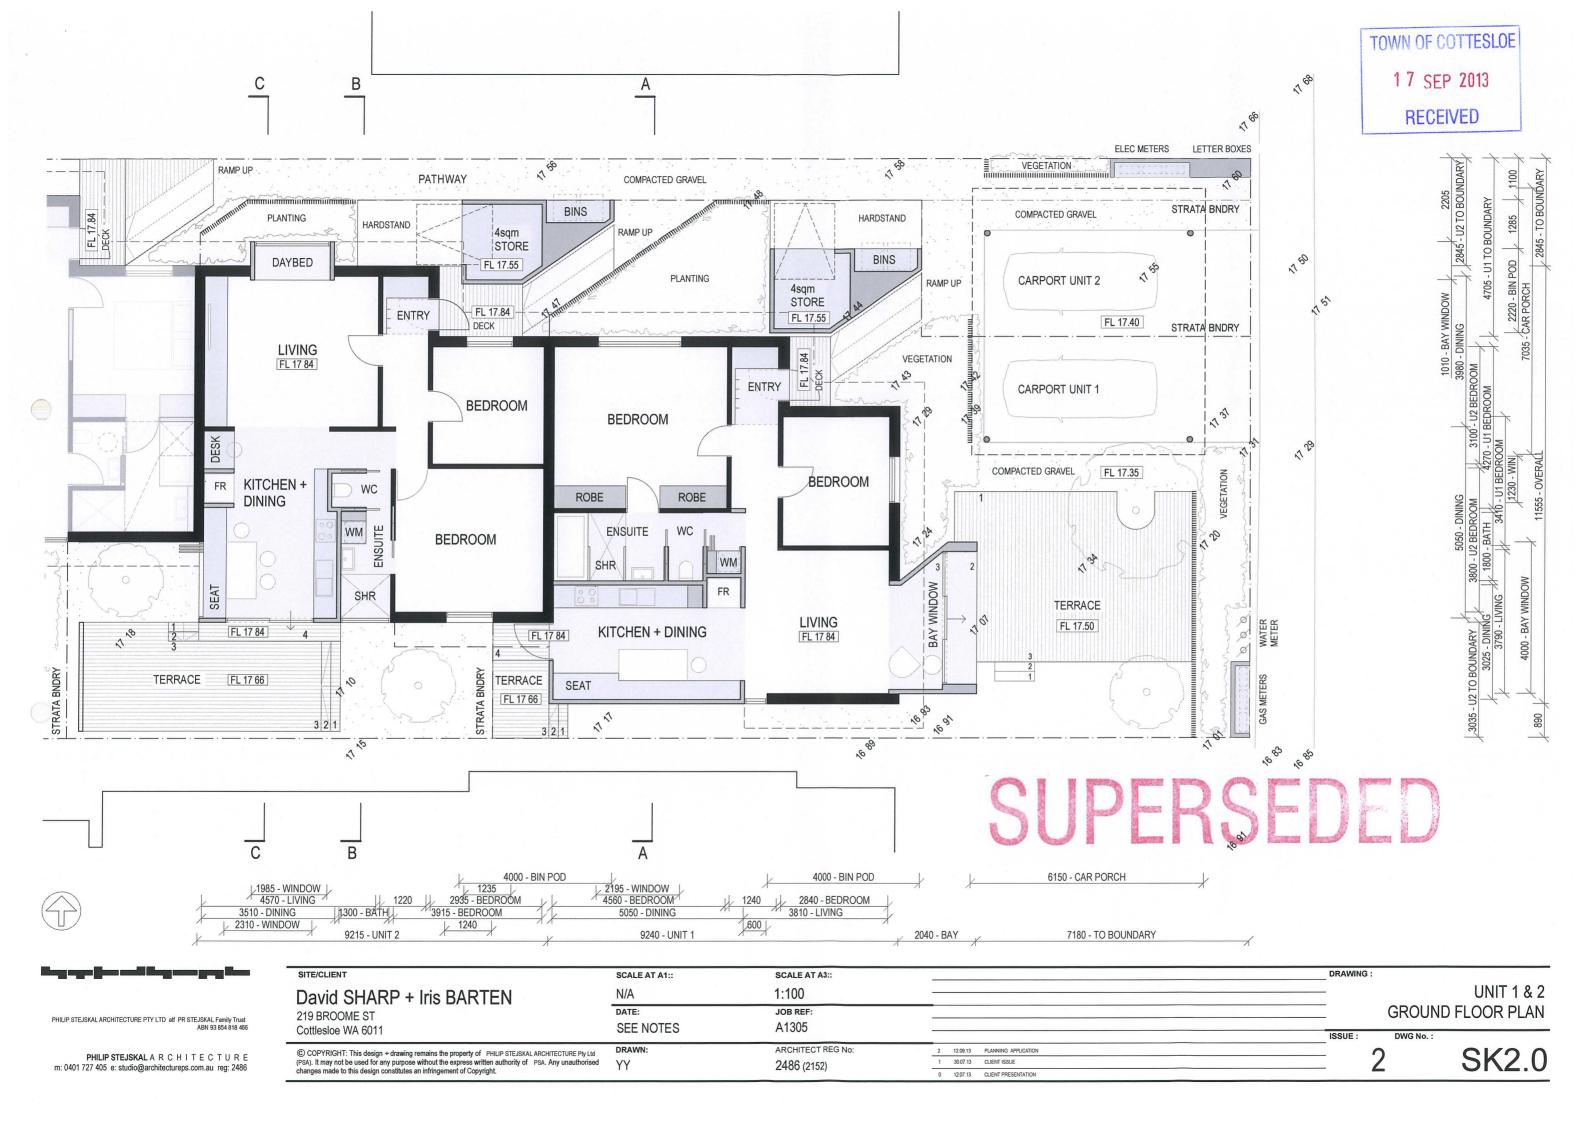


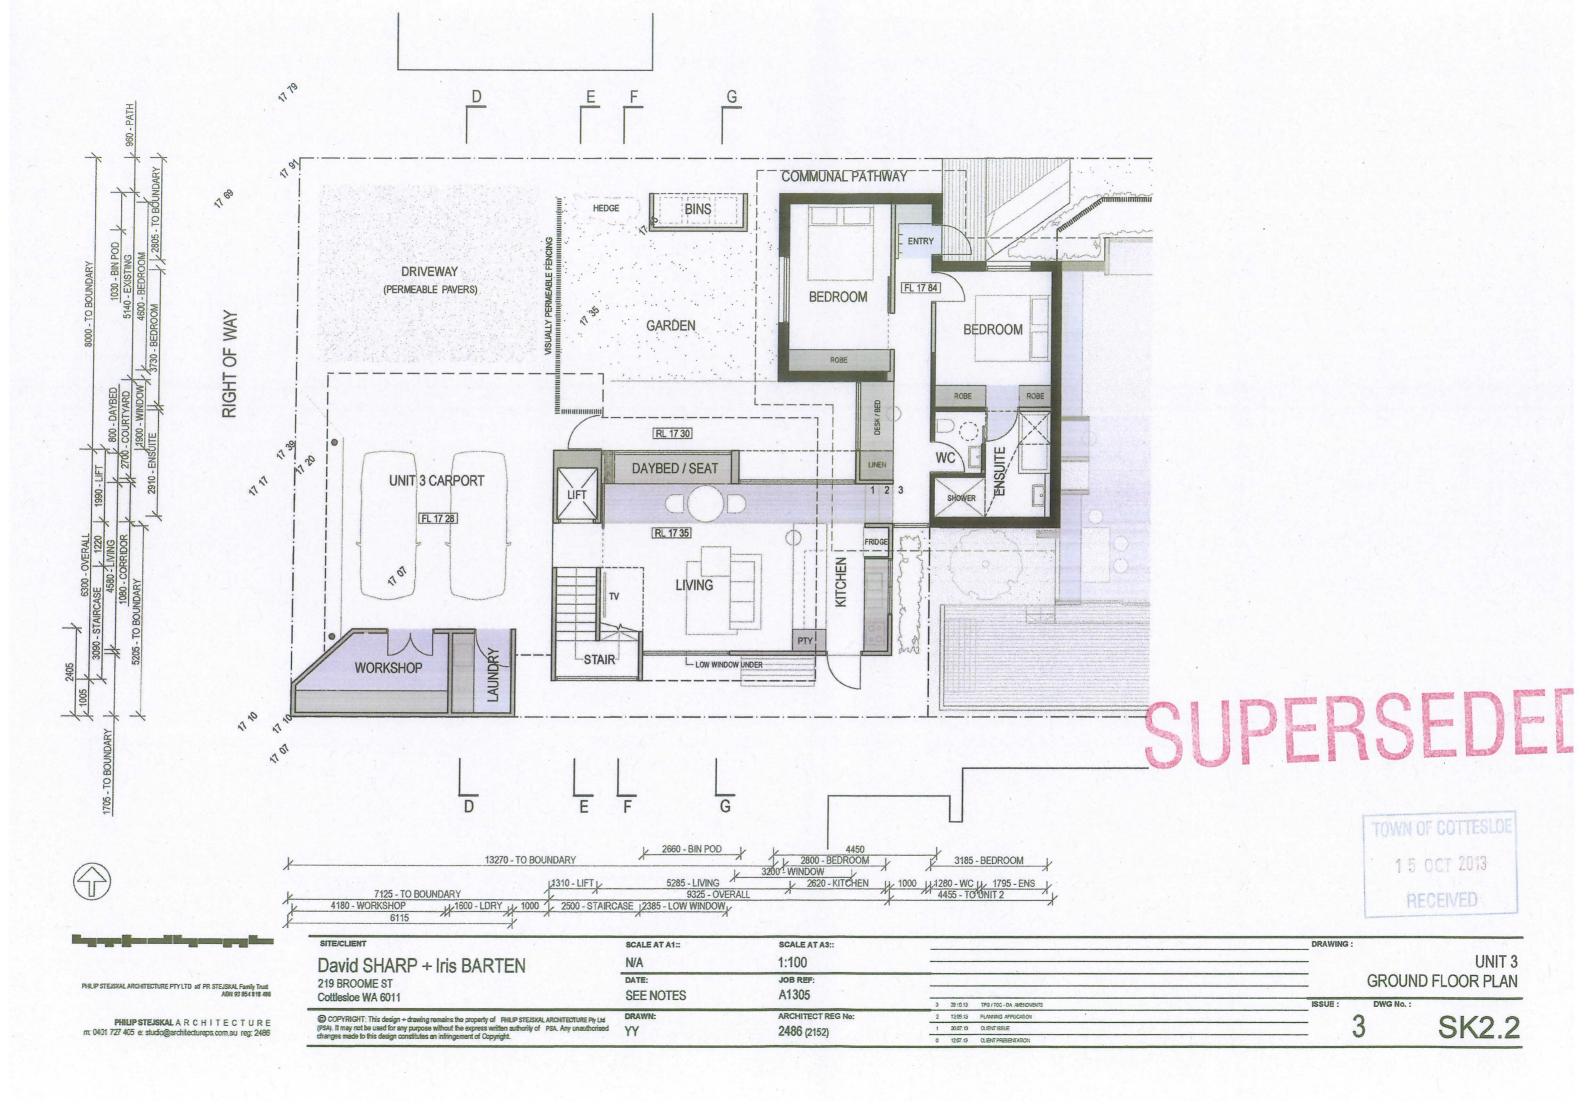

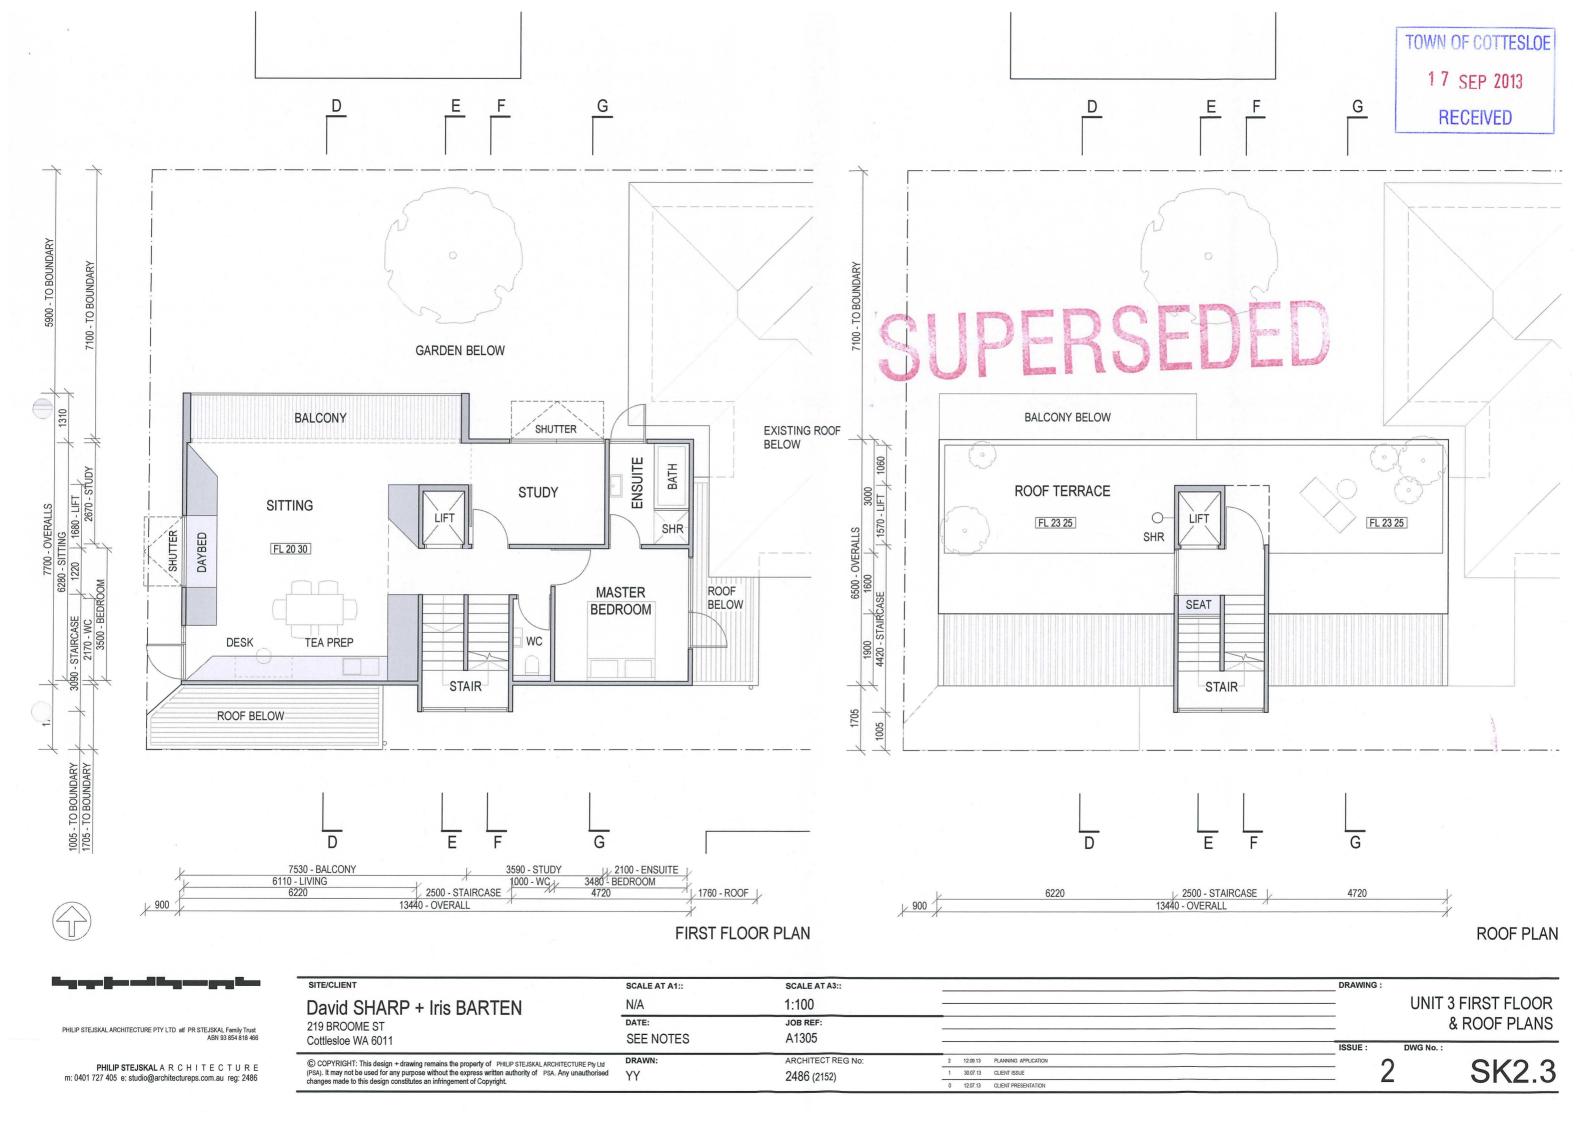

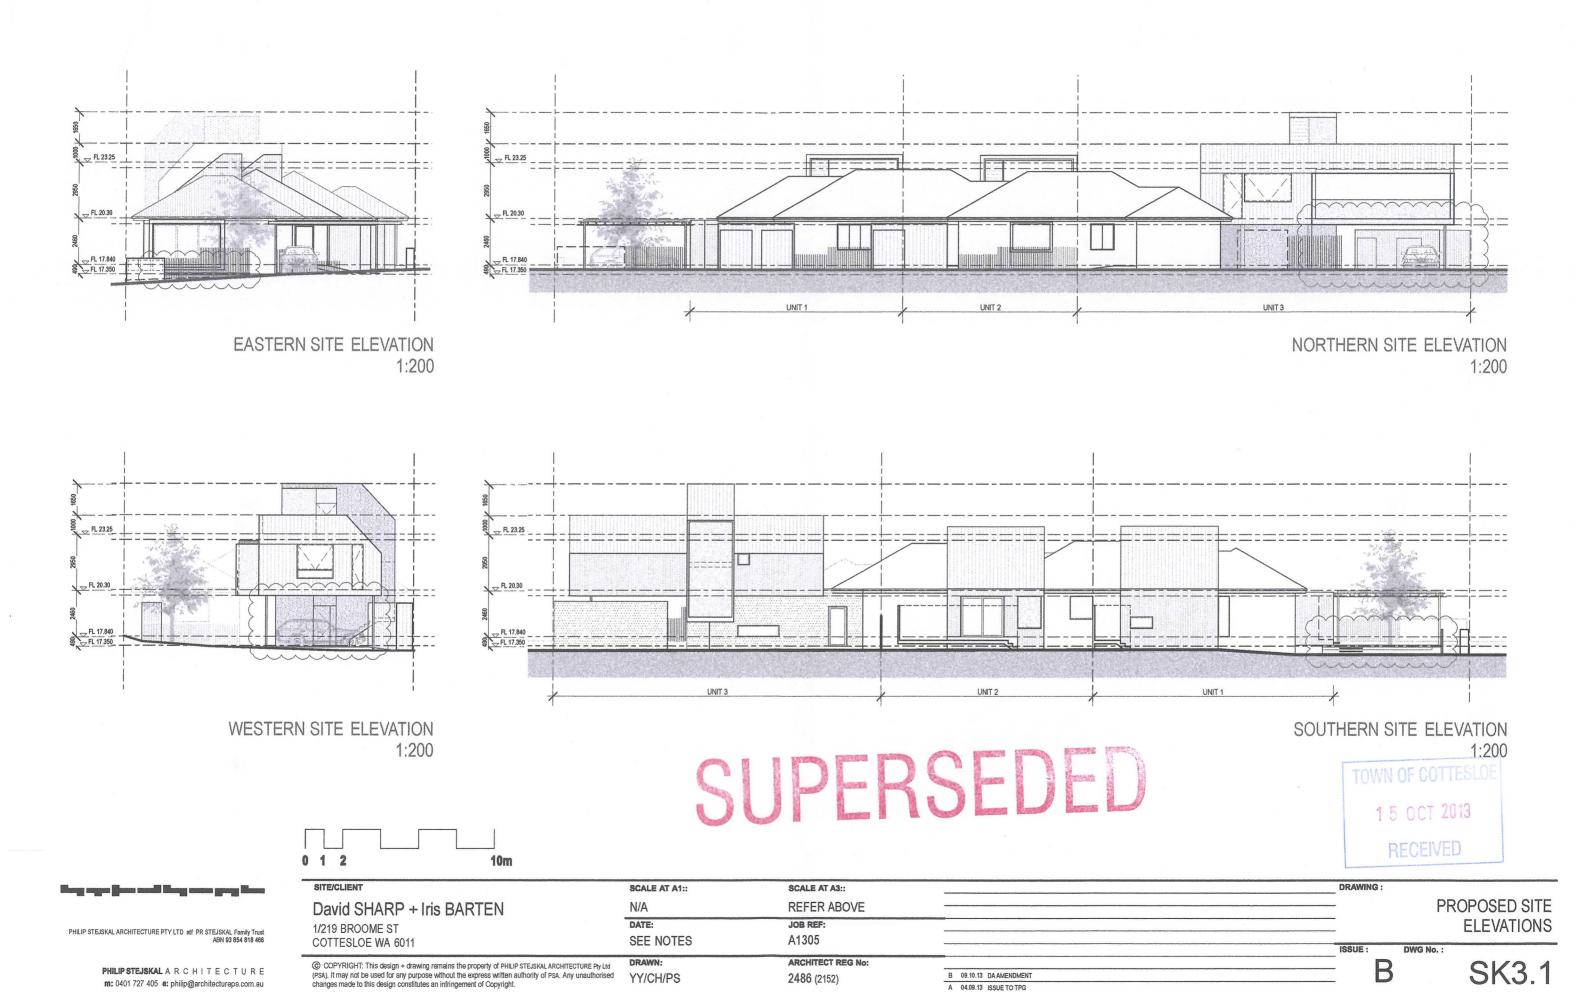

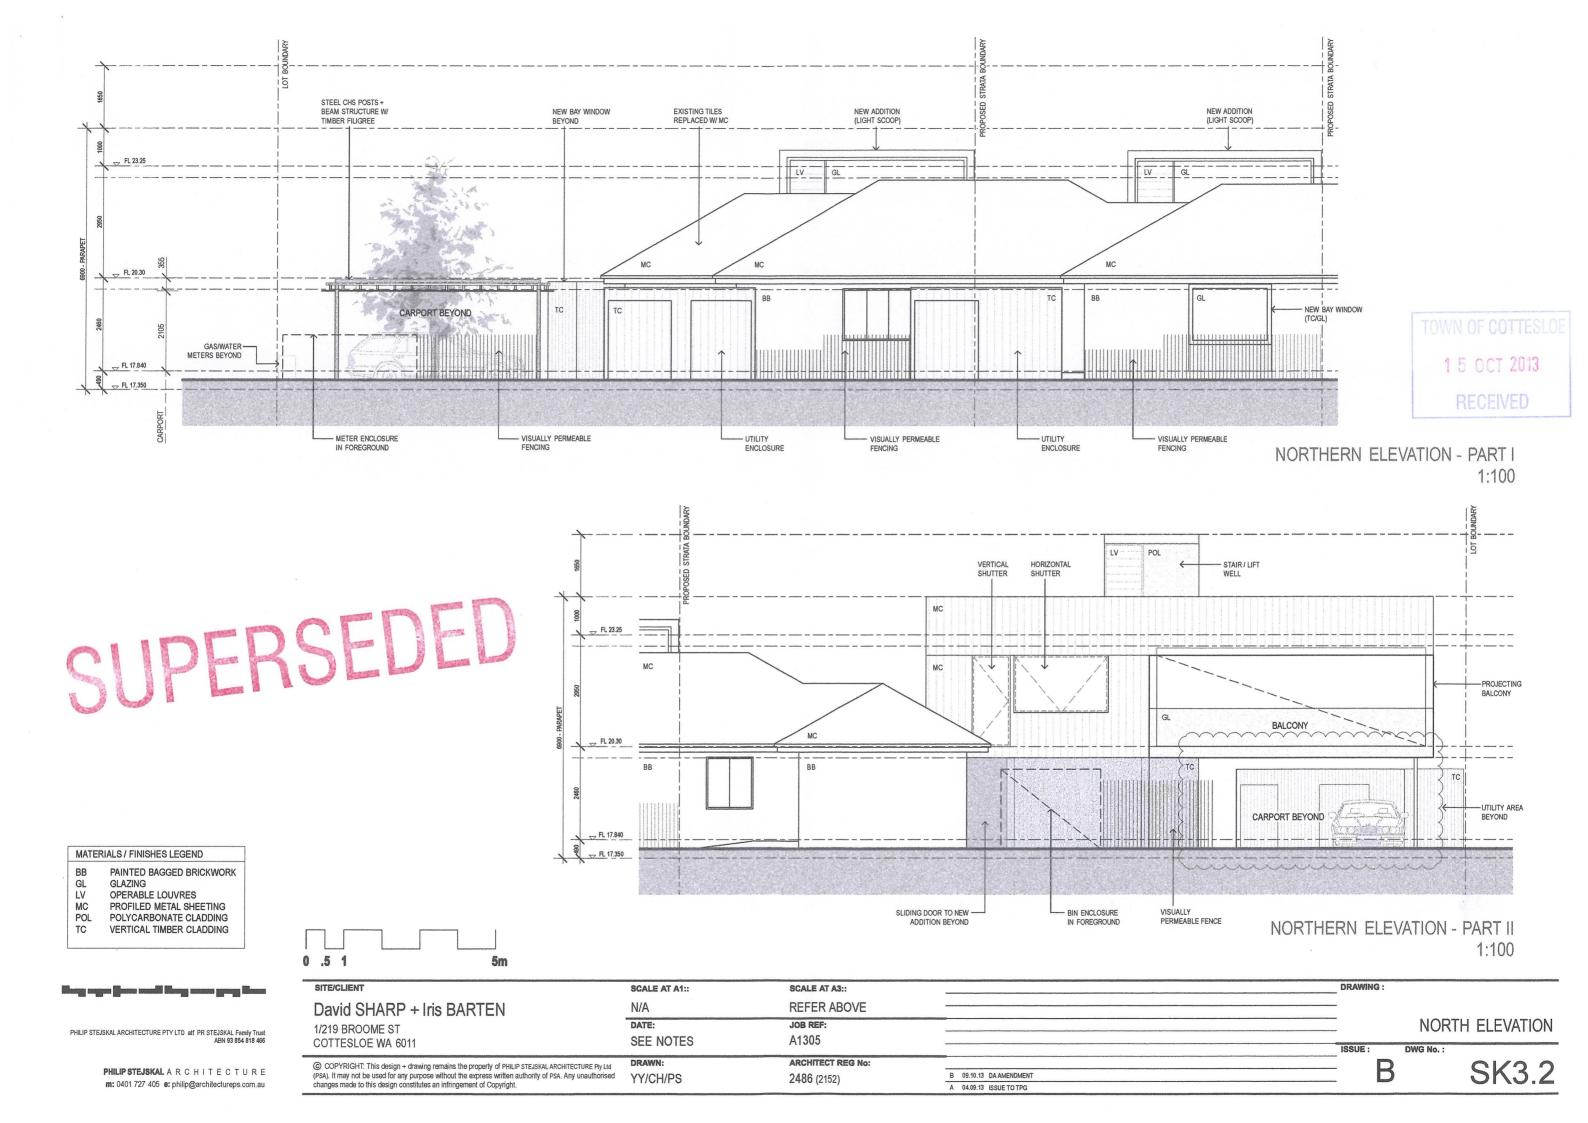

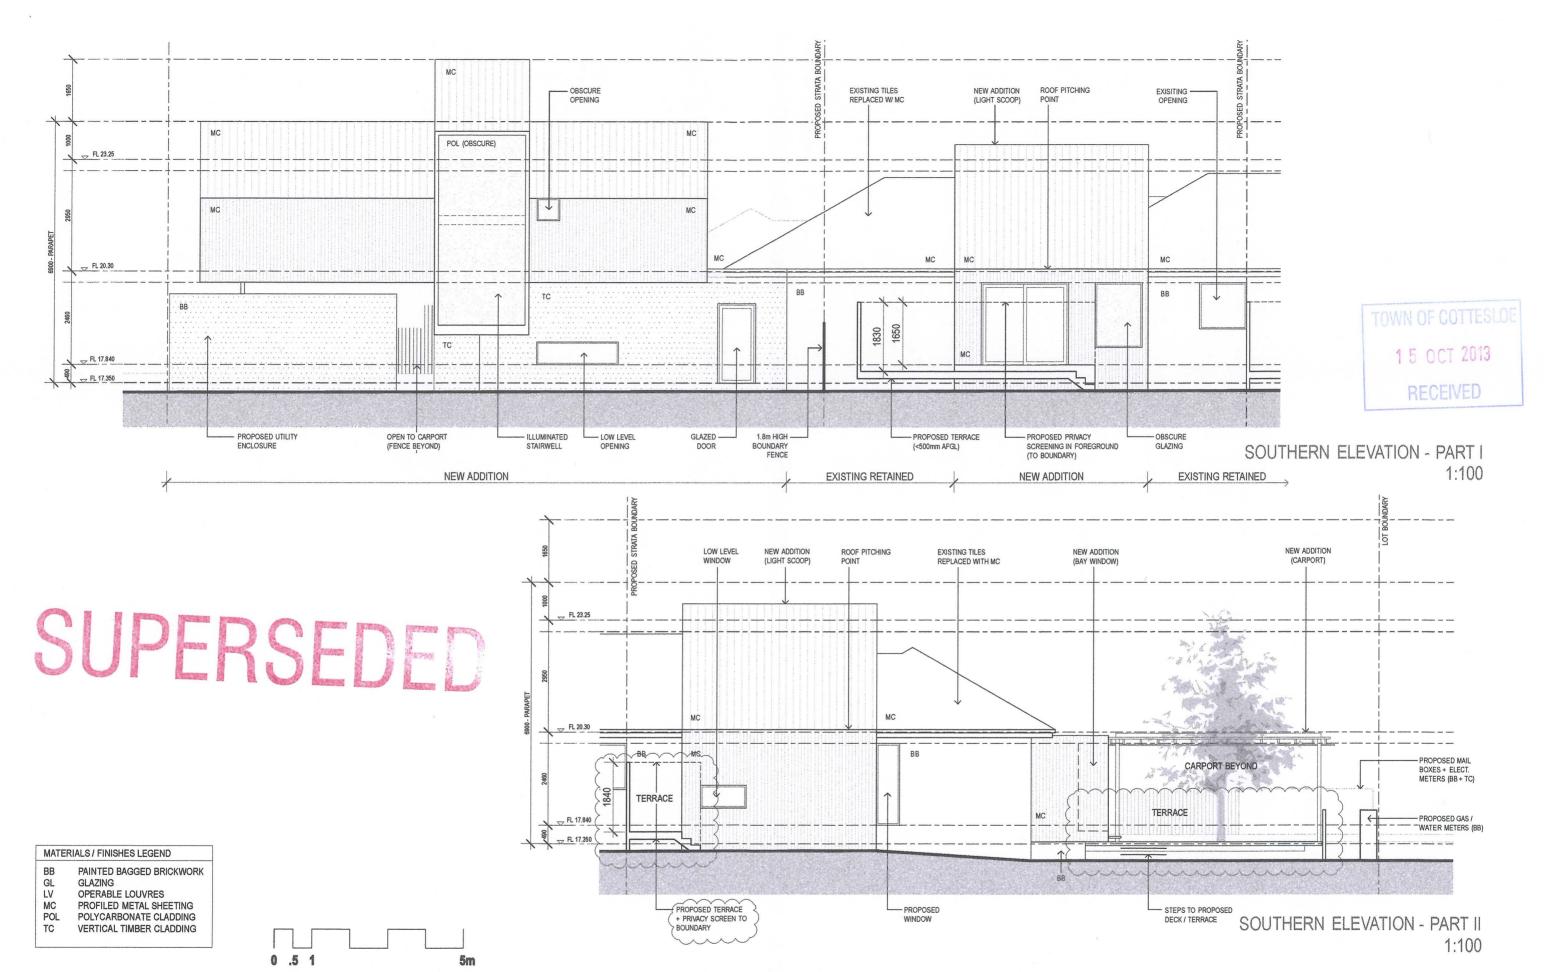

2486 (2152)

PHILIP STEJSKAL ARCHITECTURE PTY LTD atf PR STEJSKAL Family Trust
ABN 93 854 818 466

PHILIP STEJSKAL A R C H I T E C T U R E m: 0401 727 405 e: philip@architectureps.com.au

L Family Trust 3 854 818 466

1/219 BROOME ST
COTTESLOE WA 6011

© COPYRIGHT: This design + drawing remains the property of PHILIP STEJSKAL ARCHITECTURE

David SHARP + Iris BARTEN

© COPYRIGHT: This design + drawing remains the property of PHILIP STEJSKAL ARCHITECTURE Pty Ltd (PSA). It may not be used for any purpose without the express written authority of PSA. Any unauthorised changes made to this design constitutes an infringement of Copyright.

YY/CH/PS

 SCALE AT A1::
 SCALE AT A3::
 DRAWING:

 N/A
 REFER ABOVE
 PRAWING:

 DATE:
 JOB REF:
 JOB REF:

 SEE NOTES
 A1305
 ISSUE:


 DRAWN:
 ARCHITECT REG No:

B 09.10.13 DA AMENDMENT

A 04.09.13 ISSUE TO TPG

SOUTH ELEVATION

В

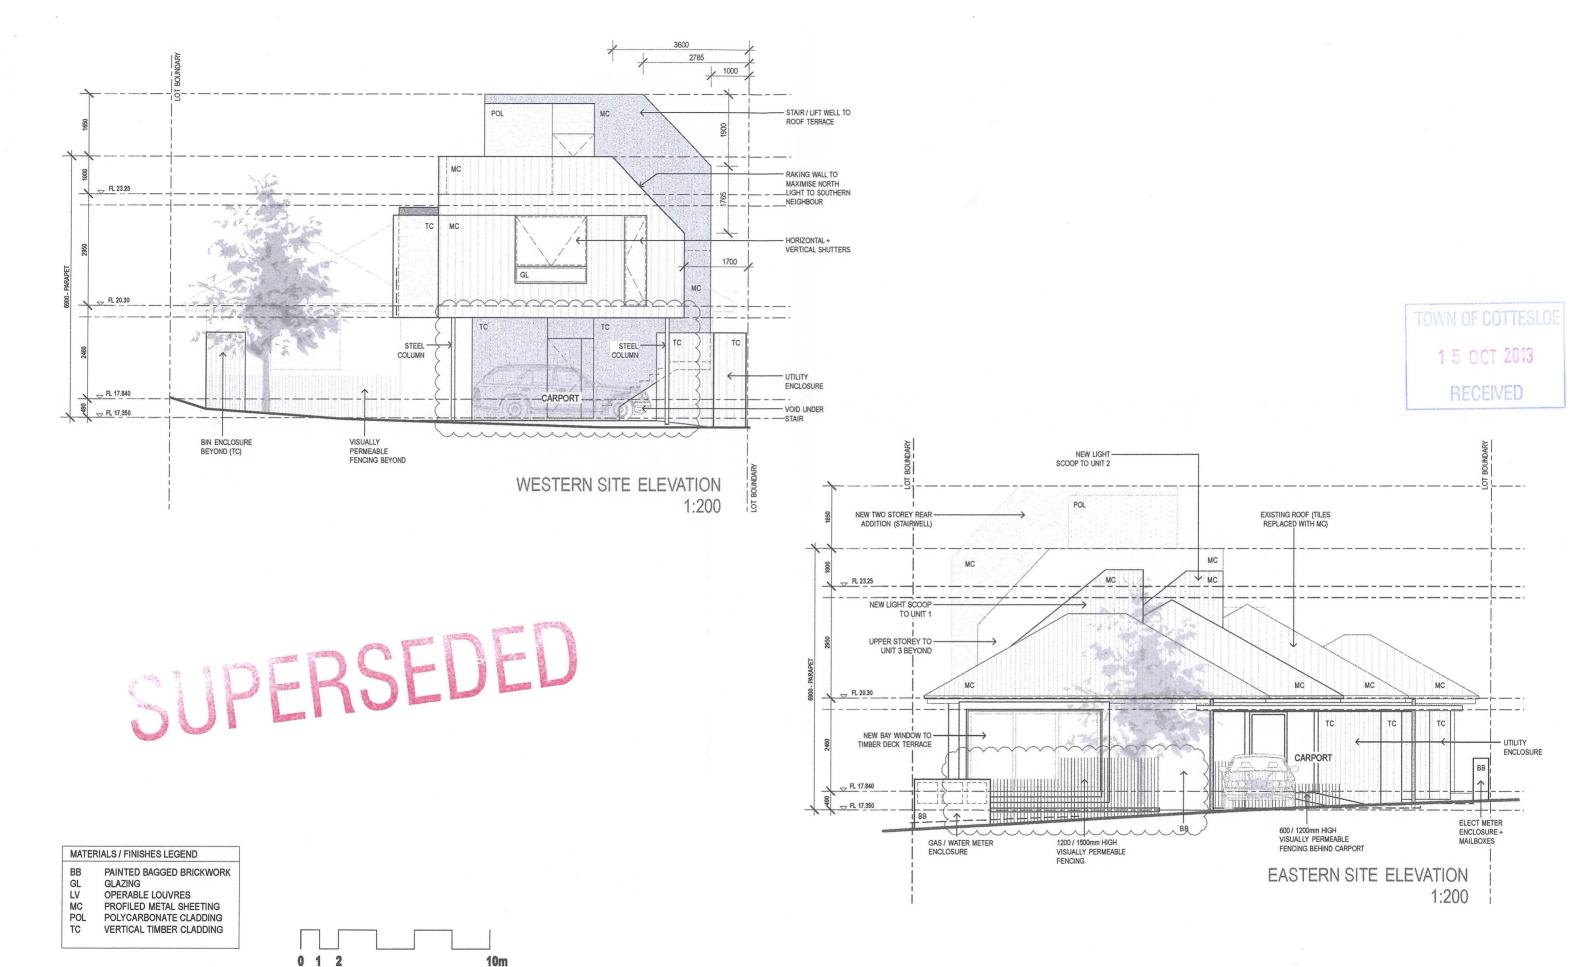

PHILIP STEJSKAL ARCHITECTURE PTY LTD atf PR STEJSKAL Family Trust ABN 93 854 818 466

PHILIP STEJSKAL A R C H I T E C T U R E m: 0401 727 405 e: philip@architectureps.com.au

SITE/CLIENT

David SHARP + Iris BARTEN 1/219 BROOME ST COTTESLOE WA 6011

© COPYRIGHT: This design + drawing remains the property of PHILIP STEUSKAL ARCHITECTURE Pty Ltd (PSA). It may not be used for any purpose without the express written authority of PSA. Any unauthorised changes made to this design constitutes an infringement of Copyright.

SCALE AT A1:: SCALE AT A3:: N/A DATE:

YY/CH/PS

JOB REF: SEE NOTES A1305

2486 (2152)

REFER ABOVE ISSUE : ARCHITECT REG No:

B 09.10.13 DA AMENDMENT

A 04.09.13 ISSUE TO TPG


EAST & WEST ELEVATIONS

DRAWING:

DWG No. : B SK3.4

TOWN OF COTTESLOE

17 SEP 2013

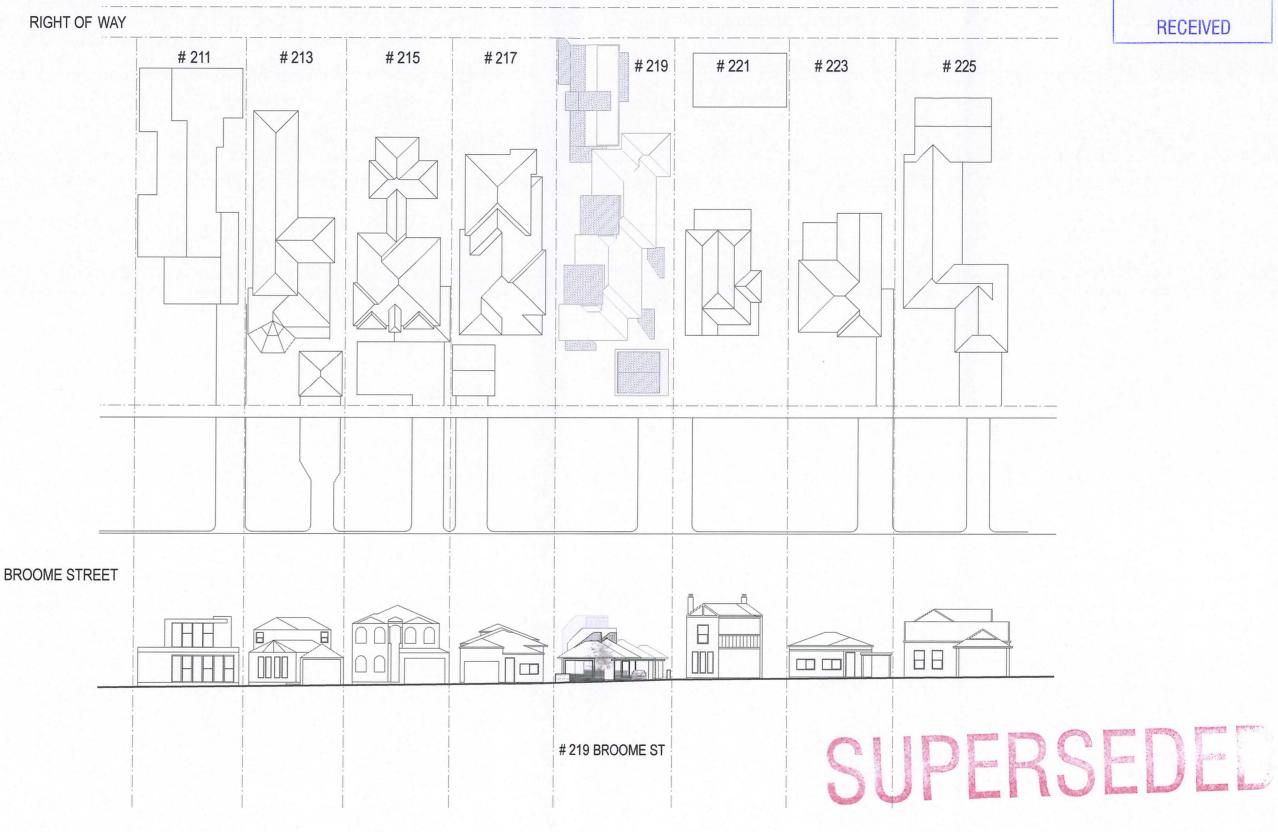

PHILIP STEJSKAL ARCHITECTURE PTY LTD atf PR STEJSKAL Family Trust ABN 93 854 818 466

PHILIP STEJSKAL A R C H I T E C T U R E m: 0401 727 405 e: philip@architectureps.com.au David SHARP + Iris BARTEN 1/219 BROOME ST COTTESLOE WA 6011

© COPYRIGHT: This design + drawing remains the property of PHILIP STEJSKAL ARCHITECTURE Pty Ltd

(PSA). It may not be used for any purpose without the express written authority of PSA. Any unauthorised changes made to this design constitutes an infringement of Copyright.

SITE/CLIENT

SCALE AT A1:: SCALE AT A3:: N/A DATE: JOB REF: SEE NOTES

REFER ABOVE A1305 ARCHITECT REG No: YY/CH/PS 2486 (2152)

A XX.09.13 ISSUE TO TPG

STREET ELEVATION

ISSUE: DWG No. :

DRAWING:



SUPERSEDED

B 09.10.13 DA AMENDMENT

A 12.09.13 PLANNING APPLICATION

1 5 OCT 2013 RECEIVED

PHILIP STEJSKAL ARCHITECTURE PTY LTD atf PR STEJSKAL Family Trust ABN 93 854 818 466

PHILIP STEJSKAL A R C H I T E C T U R E m: 0401 727 405 e: philip@architectureps.com.au David SHARP + Iris BARTEN 1/219 BROOME ST COTTESLOE WA 6011

© COPYRIGHT: This design + drawing remains the property of PHILIP STEJSKAL ARCHITECTURE Pty Ltd (PSA). It may not be used for any purpose without the express written authority of PSA. Any unauthorised changes made to this design constitutes an infringement of Copyright.

SCALE AT A1::

SEE NOTES

N/A

DATE:

DRAWN:

YY/CH/PS


REFER ABOVE JOB REF: A1305 ARCHITECT REG No:

2486 (2152)


SCALE AT A3::

DRAWING:

LANEWAY PERSPECTIVE

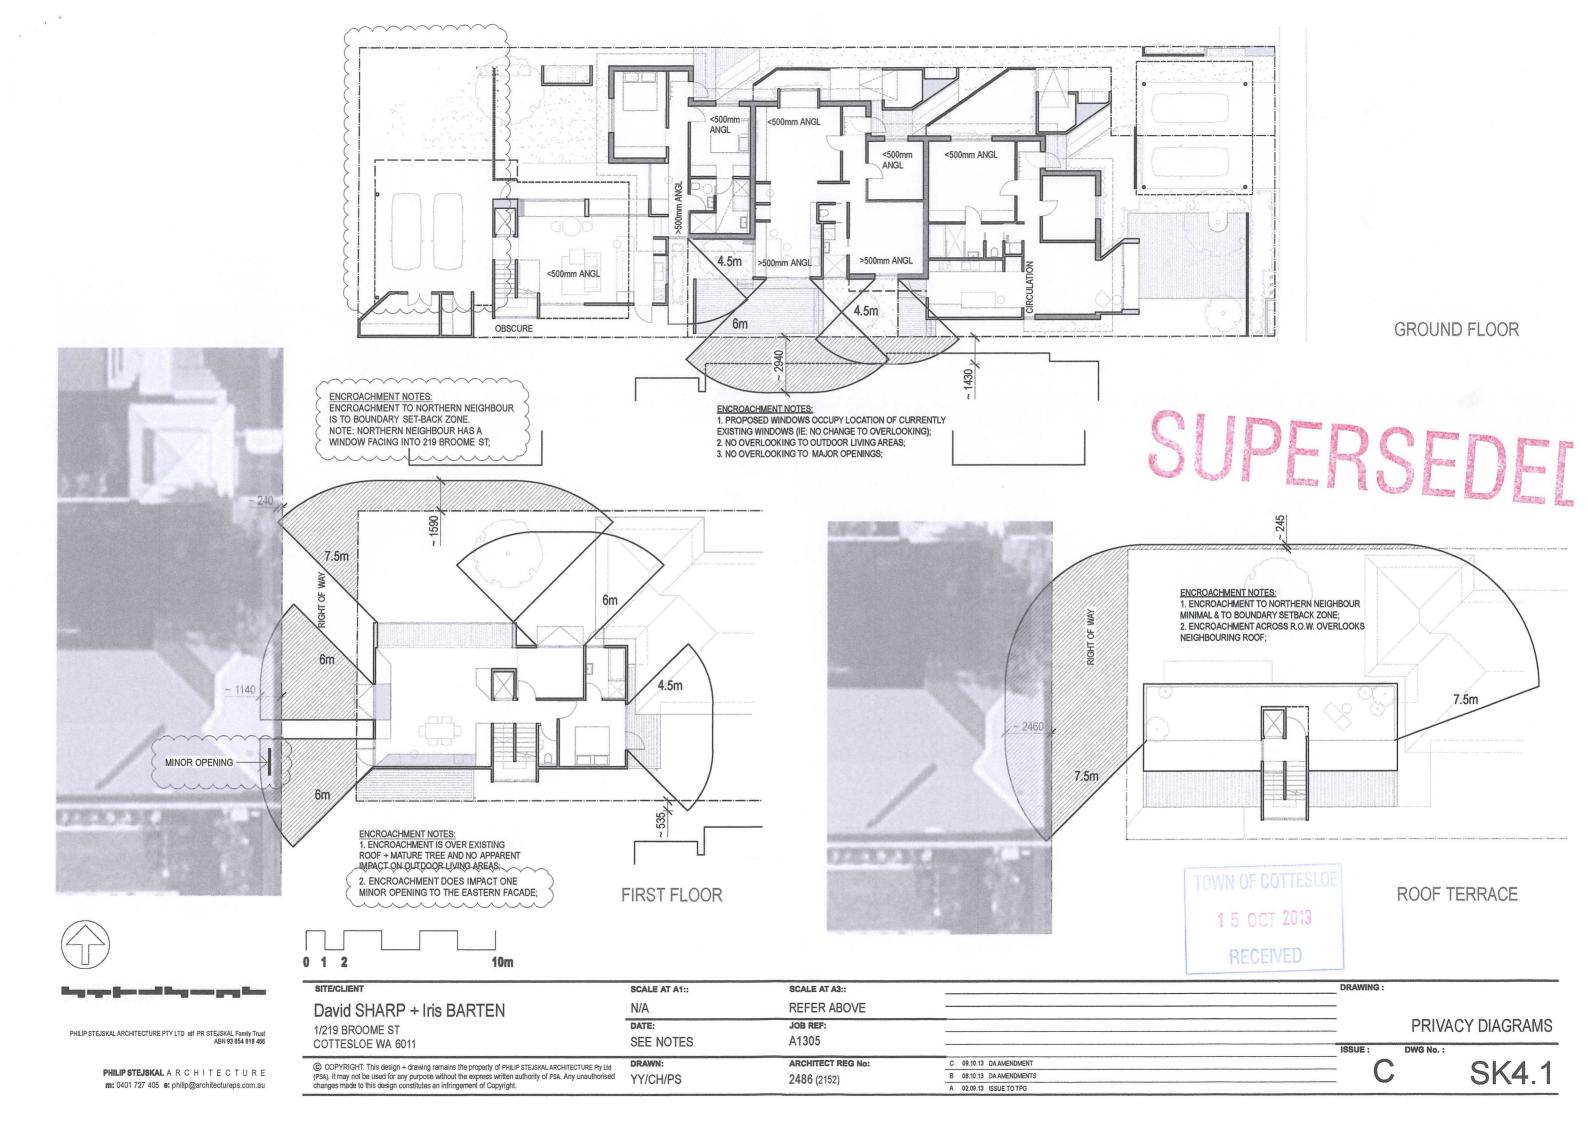

TOWN OF COTTESLOE 17 SEP 2013 RECEIVED

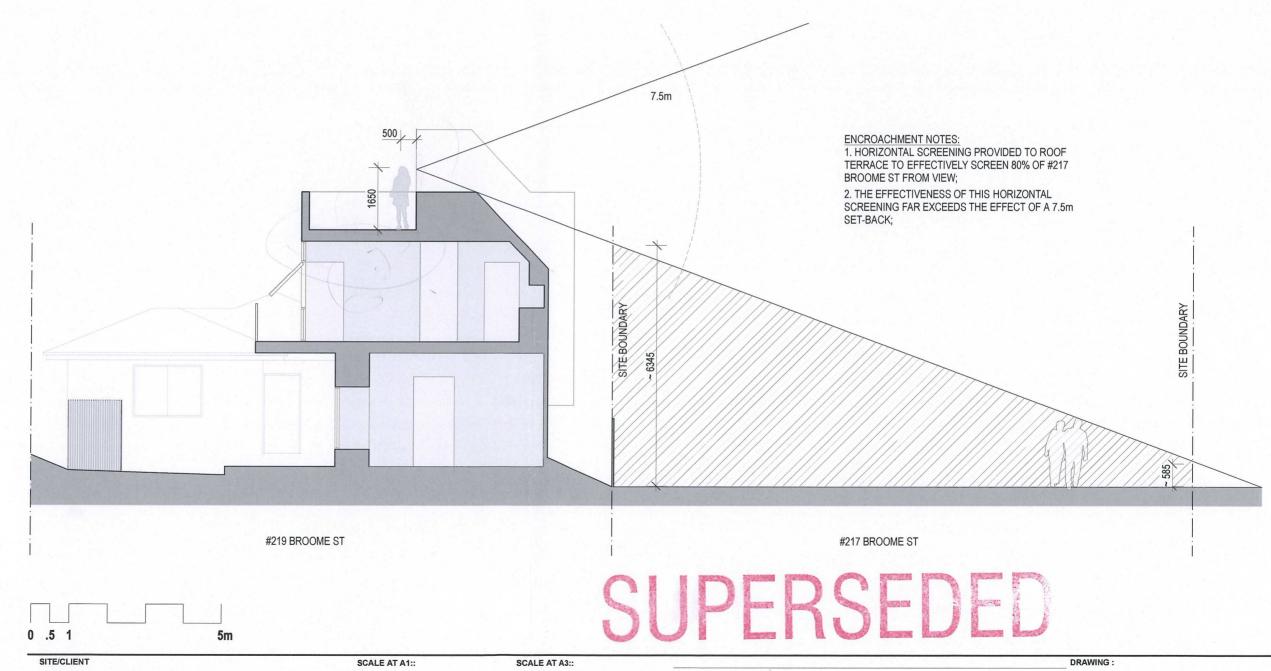

PHILIP STEJSKAL ARCHITECTURE PTY LTD atf PR STEJSKAL Family Trust ABN 93 854 818 466

PHILIP STEJSKAL A R C H I T E C T U R E m: 0401 727 405 e: philip@architectureps.com.au

David SHARP + Iris BARTEN 1/219 BROOME ST

COTTESLOE WA 6011 © COPYRIGHT: This design + drawing remains the property of PHILIP STEJSKAL ARCHITECTURE Pty Ltd (PSA). It may not be used for any purpose without the express written authority of PSA. Any unauthorised changes made to this design constitutes an infringement of Copyright.

N/A

DATE: SEE NOTES

DRAWN: YY/CH/PS

REFER ABOVE JOB REF:

2486 (2152)

A1305


ARCHITECT REG No:

A XX.09.13 ISSUE TO TPG

PRIVACY DIAGRAMS

ISSUE: DWG No. :

SK4.2

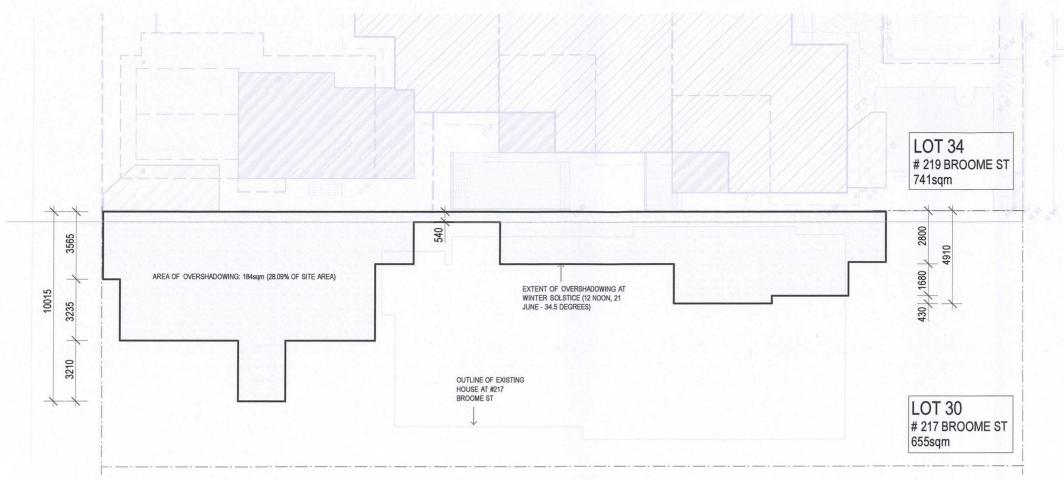


12 NOON WINTER SOLSTICE 21 JUNE; SUN ANGLE: 34.5 DEG OVERSHADOWING PLAN

TOWN OF COTTESLOE

17 SEP 2013

RECEIVED

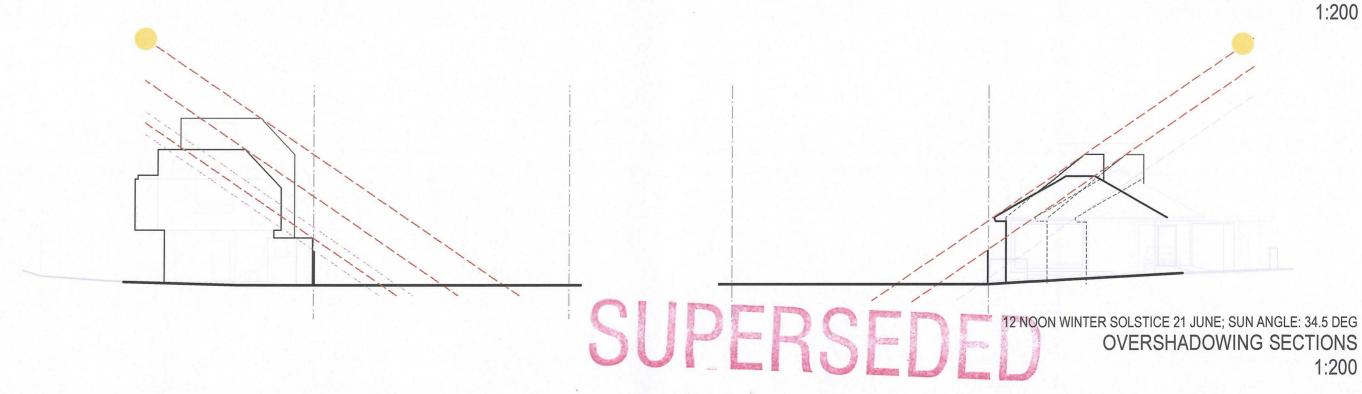

PHILIP STEJSKAL ARCHITECTURE PTY LTD atf PR STEJSKAL Family Trust ABN 93 854 818 466

> PHILIP STEJSKAL A R C H I T E C T U R E m: 0401 727 405 e: philip@architectureps.com.au

SITE/CLIENT SCALE AT A3:: DRAWING: SCALE AT A1:: N/A David SHARP + Iris BARTEN DATE: JOB REF: **OVERSHADOWING** 1/219 BROOME ST SEE NOTES A1305 COTTESLOE WA 6011 ISSUE : DWG No. : ARCHITECT REG No: © COPYRIGHT: This design + drawing remains the property of PHILIP STEJSKAL ARCHITECTURE Pty Ltd (PSA). It may not be used for any purpose without the express written authority of PSA. Any unauthorised changes made to this design constitutes an infringement of Copyright. DRAWN: SK4.3 YY/CH/PS 2486 (2152) A XX.09.13 ISSUE TO TPG



SUPERSEDED

A XX.09.13 ISSUE TO TPG

TOWN OF COTTESLOE

17 SEP 2013

RECEIVED

سا ودر سد ودا الد ساز دود ودا

PHILIP STEJSKAL ARCHITECTURE PTY LTD atf PR STEJSKAL Family Trust ABN 93 854 818 466

> PHILIP STEJSKAL A R C H I T E C T U R E m: 0401 727 405 e: philip@architectureps.com.au

David SHARP + Iris BARTEN

1/219 BROOME ST COTTESLOE WA 6011

SITE/CLIENT

© COPYRIGHT: This design + drawing remains the property of PHILIP STEJSKAL ARCHITECTURE Pty Ltd (PSA). It may not be used for any purpose without the express written authority of PSA. Any unauthorised changes made to this design constitutes an infringement of Copyright.

SCALE AT A1:: SCALE AT A3::

N/A REFER ABOVE

N/A REFER

DATE: JOB REF:
SEE NOTES A1305

DRAWN: ARCHITECT REG No: YY/CH/PS 2486 (2152)

DRAWING:

STREET PERSPECTIVE

ISSUE:

DWG No. :



SUPERSEDED

A 12.09.13 PLANNING APPLICATION

TOWN OF COTTESLOE

17 SEP 2013

RECEIVED

Name and Post and Rose was not been

PHILIP STEJSKAL ARCHITECTURE PTY LTD atf PR STEJSKAL Family Trust
ABN 93 854 818 466

PHILIP STEJSKAL A R C H I T E C T U R E m: 0401 727 405 e: philip@architectureps.com.au David SHARP + Iris BARTEN

1/219 BROOME ST COTTESLOE WA 6011

© COPYRIGHT: This design + drawing remains the property of PHILIP STEJSKAL ARCHITECTURE Pty Ltd (PSA). It may not be used for any purpose without the express written authority of PSA. Any unauthorised changes made to this design constitutes an infringement of Copyright.

 SCALE AT A1::
 SCALE AT A3::

 N/A
 REFER ABOVE

 DATE:
 JOB REF:

 SEE NOTES
 A1305

 DRAWN:
 ARCHITECT REG No:

DRAWN: ARCHITECT REG No: YY/CH/PS 2486 (2152)

DRAWING:

LANEWAY PERSPECTIVE

ISSUE: DWG N

DWG No. .